

FELLNER

GENERAL NOTES

- THE GENERAL CONTRACTOR SHALL BE RESPONSIBLE FOR CHECKING ALL CONTRACT DOCUMENTS, FIELD CONDITIONS, AND DIMENSIONS FOR ACCURACY. IF THERE ARE ANY QUESTIONS REGARDING THESE OR OTHER COORDINATION ISSUES, THE CONTRACTOR IS RESPONSIBLE FOR OBTAINING CLARIFICATION FROM THE ARCHITECT VIA WRITTEN RFI TO THE ARCHITECT BEFORE PROCEEDING WITH THE WORK IN QUESTION OR ANY RELATED WORK.
- ALL WORK NOTED ""BY OTHERS"" OR ""N.I.S"" IS TO BE ACCOMPLISHED BY ANOTHER CONTRACTOR OR HIS/HER SUBCONTRACTORS AND IS NOT BE PART OF THE CONTRACT SUM
- . THE CONTRACT DOCUMENTS CONSIST OF THE ARCHITECTURAL DRAWINGS, SPECIFICATION BOOK OR SPREADSHEET, STRUCTURAL DRAWINGS, GEOTECHNICAL REPORT, SURVEY, AND ANY OTHER RELATED DOCUMENTATION. CONTRACT DOCUMNETS SHALL BE CONSIDERED IN WHOLE AND ARE NOT INTENDED TO BE SEPARATED.
- . ALL CONSTRUCTION IS TO COMPLY WITH ALL APPLICABLE CODES, ORDINANCES AND REGULATIONS (CITY, STATE, AND NATIONAL).
- . CARE IS TO BE TAKEN AT ALL TIMES TO PROTECT OWNER'S SITE AND PROPERTY.
- S. THE GENERAL CONTRACTOR IS RESPONSIBLE FOR ALL FEES AND PERMITS NECESSARY TO COMPLETE THE WORK DESCRIBED IN THE CONTRACT DOCUMENTS.
- PROVIDE FIRESTOPPING IN ALL THE FOLLOWING LOCATIONS:
- A. IN CONCEALED SPACES OF STUD WALLS AND PARTITIONS INCLUDING FURRED OUT SPACES, CEILINGS, AND FLOORS.
- B. AT ALL INTERCONNECTIONS BETWEEN VERTICAL AND HORIZONTAL SPACES SUCH AS SOFFITS. DROPPED CEILINGS, COVE CEILINGS, ETC.
- C. IN CONCEALED SPACES AT STAIR STRINGERS AT THE TOP AND BOTTOM OF THE RUN.
- D. AT OPENINGS AROUND VENTS, PIPES, CHIMNEYS, AND FIRE PLACES AT CEILING AND FLOOR LEVEL WITH NON COMBUSTIBLE MATERIALS.
- 8. PROTECT ALL TREES WHICH ARE TO REMAIN (REFERENCE SITE PLAN FOR TREE PROTECTION GUIDELINES).
- 9. DO NOT SCALE DRAWINGS. USE WRITTEN DIMENSIONS ONLY.
- 10. ALL DIMENSIONS, NOTES, FINISHES AND FIXTURES SHOWN ON TYPICAL FLOOR PLANS, SECTIONS, OR DETAILS SHALL APPLY TO ALL SIMILAR, SYMMETRICAL OR OPPOSITE HAND SECTIONS AND DETAILS.
- 1. SUBMIT TO THE ARCHITECT FOR REVIEW, PRIOR TO CONSTRUCTION, ALL REQUIRED SHOP DRAWINGS, SAMPLES AND PRODUCT INFORMATION AS CALLED FOR BY THE PROJECT SPECIFICATIONS.
- 12. REFER TO OWNER'S LEGAL PLAT SURVEY FOR FURTHER INFORMATION REGARDING ""IRON RODS FOUND"", ""BASE CORNERS"", ""BENCHMARK ELEVATIONS"".
- 13. REFER TO OWNER'S SURVEY REGARDING SPECIAL FLOOD HAZARD AREAS (BY FEMA) AND OTHER FLOODPLAIN INFORMATION NOT DESCRIBED IN THE SITE PLAN DRAWING.
- 14. DESIGN SPECIFICATIONS ARE AN INTEGRAL PART OF THESE DRAWINGS.
- 15. ALL DIMENSIONS ARE TO FRAMING UNLESS NOTED OTHERWISE.

APPLICABLE CODES

INTERNATIONAL RESIDENTIAL CODE (IRC) 2015 INTERNATIONAL WILDLAND-URBAN INTERFACE CODE (IWUIC) 2015 NATIONAL ELECTRICAL CODE (NEC) 2017 INTERNATIONAL MECHANICAL CODE (UMC) 2015 INTERNATIONAL PLUMBING CODE (UPC) 2015 INTERNATIONAL FIRE CODE (IFC) 2015 INTERNATIONAL ENERGY CONSERVATION CODE (IECC) 2015

VICINITY MAP

Area Description

Covered deck Covered porch

Covered patio

Other roofed areas

Total Building Area

Uncovered patio

Uncovered deck

Pool (surface area)

Total Impervious Coverage

Added Impervious Coverage %

Total Impervious Coverage %

Spa (surface area)

Total Building Coverage

Other flatwork (pool coping, retaining walls,

Existing Impervious Coverage % Before Demo

1st floor

2nd floor


3rd floor

Garage

Balcony

Driveway

Sidewalks

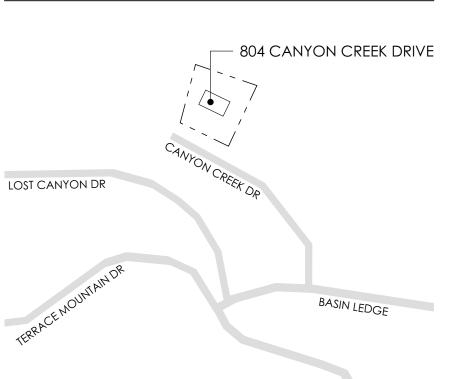

IMPERVIOUS COVER CALCULATIONS

Existing Sq Ft

1134.0

1464.0

480.0

879.0

4053.0

1614.0

1902.0

257.0

537.0

586.0

575.0

5489.0

27181.4

20.19%

0.28%

20.48%

LOT SIZE

PROJECT INFORMATION

OWNER: JAKE FELLNER ADDRESS: 804 CANYON CREEK DRIVE WESTLAKE HILLS, TX 78746

ZONING: R-1

Added Sq Ft

469.0

1498.0

168.0

-590.0

1449.0

1642.0

-854.0

-32.0

-537.0

-311.0

LEGAL DESCRIPTION:

LOT 18 BLK P STONEHEDGE ESTATES BLK P ABS 75 SUR 503 BENHAM A L D ACR .104

MAX IMPERVIOUS COVERAGE: MAX BLDG HEIGHT:

Total Sq Ft

1603.0

2962.0

648.0

289.0

5502.0

3256.0

1048.0

225.0

773.0

264.0

5566.0

DESCRIPTION: TOTAL DEMOLITION OF 2,448 SF WOOD FRAMED RESIDENCE, SLAB ON GRADE FOUNDATION AND POOL. CONSTRUCTION OF A WOOD FRAMED TWO-STORY 4 BED/4.5 BATHS SINGLE FAMILY RESIDENCE WITH AN ATTACHED TWO CAR

ARCHITECT: POINT B DESIGN GROUP 1009 W 6TH ST SUITE 207 **AUSTIN, TX 78703**

> T. 512.568.9803 STRUCTURAL ENGINEER:

PROJECT TEAM

STATIX ENGINEERING T. 512.222.9849 CIVIL ENGINEER:

DUNAWAY | BEC 5707 SOUTHWEST PKWY BUILDING 2 STE 250 **AUSTIN, TX 78735** T. 832.240.4492

ELECTRIC ENGINEER: VOLTHOUSE ELECTRIC, LLC

PO BOX 1162 MANCHACA, TX 78652

PLUMBING ENGINEER: DOUBLE AA PLUMBING,LLC 7313 GILBERT RD. MANOR, TX 78635

MECHANICAL ENGINEER: ELITE AUSTIN AC 7101 BURLESON RD. AUSTIN, TX 78744

GENERAL CONTRACTOR: MATT CARSWELL CARSWELL BUILDERS, LLC 5901 OAKCLAIRE LN. AUSTIN, TX. 78735 T. 512.965.5391

SEPTIC ENGINEER: BETTRIDGE SYSTEMS 128 HIGHLANDER ST. **AUSTIN, TX 78734** T. 512.814.7020

HVAC DESIGNER: FRESH AIR 3306 DALTON ST AUSTIN, TX 78745 T. 512.814.7638


Point B Design Group 1009 W 6TH ST STE 207 AUSTIN, TX 78703 o. 512-568-9803

DRAWING INDEX

NO.	TITLE	ISSUED FOR CONSTRUCTION 1/21/2025
A0.00	COVER SHEET	0
A0.01	ARCHITECTURAL NOTES	0
D1.00	SITE DEMO PLAN	0
A1.00	SITE PLAN	0
A1.01	SITE PLAN - POOL	0
A1.02	SITE PLAN - TREE PLAN	0
A2.00	FOUNDATION PLAN	0
A2.10	FLOOR PLANS	0
A2.11	FLOOR PLANS	0
A2.12	ROOF PLAN	0
A2.20	RCP	0
A2.21	RCP	0
A2.30	POWER + MECHANICAL PLAN	0
A2.31	POWER + MECHANICAL PLAN	0
A2.40	FINISH PLANS	0
A2.41	FINISH PLANS	0
A3.00	BUILDING ELEVATIONS	0
A3.01	BUILDING ELEVATIONS	0
A4.00	BUILDING SECTIONS	0
A4.01	BUILDING SECTIONS	0
A6.00	DOORS SCHEDULES	0
A6.01	WINDOW SCHEDULES	0
A6.02	WINDOW SCHEDULES	0
A6.03	SCHEDULES	0
A7.00	DETAILS	0
A7.01	DETAILS	0
A7.02	DETAILS	0
A7.03	DETAILS	0
A7.04	DETAILS	0
A7.05	DETAILS	0
A7.06	DETAILS	0
A7.07	DETAILS	0
A7.08	DETAILS	0
A7.09	DETAILS	0
A7.10	DETAILS	0
A7.11	DETAILS	0
A7.12	DETAILS	0
A7.13	DETAILS	0
A7.14	DETAILS	0
A7.15	DETAILS	0
A7.16	DETAILS	0
A7.17	DETAILS	0

FELLNER 804 CANYON WEST LAKE HI

DO NOT SCALE DRAWING

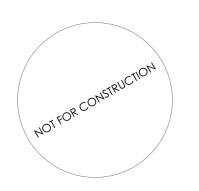

SEAL

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DRAWING TITLE: **COVER SHEET**

SCALE: AS NOTED

SCALES ARE 50% OF NOTED WHEN PRINTED ON 11 X 17 PAPER

DATE: 6/19/2025

SHEET NUMBER:



Α		E		M		S	
AB.	ANCHOR BOLT	EA.	EACH	M/m	METER	SCHED.	SCHEDULE
ABV. ACC.	ABOVE	EDF. EFOB.	ELECTRIC DRINKING FOUNTAIN EXTERIOR FACE OF BUILDING		MILLIMETER	S.C. SD	SOLID CORE STORM DRAIN
	ACCESS / ACCESSIBLE ACCESS FLOOR	EFOB.	EXPANSION JOINT	MACH. MAINT.	MACHINE MAINTENANCE	SECT.	SECTION
	. ACCESS PANEL	ELAS.	ELASTIC / ELASTOMERIC	MAS.	MASONRY	SF	SQUARE FOOT / FEET
ACM. ACOUS.	ALUMINUM COMPOSITE METAL ACOUSTICAL	ELEC. ELEV.	ELECTRICAL ELEVATOR	MATL. MAX.	MATERIAL MAXIMUM	SH SHVL.	SINGLE-HUNG SHELVES / SHELVING
A.C.T.	ACOUSTICAL CEILING TILE	EL.	ELEVATION	MECH.	MECHANICAL	SHTHG.	SHEATHING
	ADJUSTABLE	EMER.	EMERGENCY	MEP	MECHANICAL / ELECTRICAL /	SHT.	SHEET
ADJ. AD.	ADJACENT AREA DRAIN	EP. EQUIP.	EXPLOSION PROOF EQUIPMENT	MFR.	PLUMBING MANUFACTURER	SHT. GL. SHWR.	SHEET GLASS SHOWER
A.F.F.	ABOVE FINISH FLOOR	EQ.	EQUAL	MH	MANHOLE	SIM.	SIMILAR
AGG.	AGGREGATE	ESR.	ELASTIC SHEET ROOFING	MIN.	MINIMUM	SPEC.	SPECIFICATION
ALT. ALUM.	ALTERNATE ALUMINUM	E.W. EWC.	EACH WAY ELECTRIC WATER COOLER	MISC. M.L.	MISCELLANEOUS METAL LATH	SPKR. SQ.	SPEAKER SQUARE
ANCH.	ANCHOR / ANCHORAGE	EWH.	ELECTRIC WATER HEATER	MLDG.	MOULDING	S.S.	STAINLESS STEEL
ANG. ANOD.	ANGLE ANODIZED	EXH. EXIST.	EXHAUST EXISTING	M.O. MTD.	MASONRY OPENING MOUNTED	SS STAB,	SANITARY SEWER STABILIZE(D)
	APPROXIMATE	EXPAN.	EXPANSION	MTG.	MOUNTING	STAL.	STATION
ARCH.	ARCHITECT / ARCHITECTURAL	EXP.	EXPOSED	MTL.	METAL	S.T.C.	SOUND TRANSMISSION COEFFICIEN
AUTO. AUX.	AUTOMATIC AUXILIARY	EXT.	EXTERIOR	MULL.	MULLION	STD. STL.	STANDARD STEEL
AVE.	AVENUE	F				STOR.	STORAGE
AVG.	AVERAGE	FA.	FIRE ALARM	N		STRUCT.	STRUCTURE / STRUCTURAL
4/C 4/V	AIR CONDITIONING AUDIO VISUAL	F.C. FD.	FIRE CODE FLOOR DRAIN	NAT.	NATURAL NON ERESTE HOSE RIPR	SUSP. SW	SUSPENDED SWITCH
,		FE.	FIRE EXTINGUISHER	NFHB N.I.C.	NON-FREEZE HOSE BIBB NOT IN CONTRACT	SYM.	SYMMETRICAL
В		FEC.	FIRE EXTINGUISHER CABINET	NOM.	NOMINAL	SYN.	SYNTHETIC SYSTEM
BD.	BOARD	FHC. FH.	FIRE HOSE CABINET FIRE HYDRANT	NO. or # N.R.	NUMBER NOISE REDUCTION	SYS. S/AD	System Supply air diffuser
B/F BITUM.	BOTH FACES BITUMINOUS	FIN.	FINISH / FINISHED	n.r. n.r.c.	NOISE REDUCTION NOISE REDUCTION COEFFICIENT	S/A	SUPPLY AIR
BLDG.	BUILDING	FIXT. FLRG.	FIXTURE FLOORING	N.T.S.	NOT TO SCALE		
BLKG. BLK.	BLOCKING BLOCK	FLRG. FLR.	FLOORING FLOOR	0		-	
BM.	BEAM	FLSHG.	FLASHING	OA	OVERALL	T T.B.	TOWEL BAR
В.М.	BENCH MARK	FLUOR. F.P.	FLUORESCENT FIREPLACE	O.C. O.D.	ON CENTER OUTSIDE DIAMETER	TCOC	TEXTURE COATING ON CONCRETE
BOT. B.O.C.	BOTTOM BOTTOM OF CURB	F.P.W.	FLOOD PROTECTION WALL	OFCI	OWNER FURNISHED /	TEL.	TELEPHONE
BRG.	BEARING	FL.	FLOW LINE	OFOL	CONTRACTOR INSTALLED	TEMP.	TEMPERED / TEMPORARY / TEMPERATURE
BRG. PL.	BEARING PLATE	F.M. FND.	FACTORY MUTUAL FOUNDATION	OFOI	OWNER FURNISHED / OWNER INSTALLED	THK.	THICK(NESS)
BRKT. B.S.	BRACKET BOTH SIDES	F.O.	FACE OF	ОН	OVERHEAD	THRES.	THRESHOLD
BSMT.	BASEMENT	FRPF. FSEC.	FIREPROOF(ING) FOOD SERVICE EQUIPMENT	O.P. OPH	OPERABLE PARTITION OPPOSITE HAND	TINT. TKBD.	TINTED TACKBOARD
BTW. B.U.R.	BETWEEN BUILT-UP ROOFING	TSEC.	CONTRACTOR	OPNG.	OPENING	T.O.C.	TOP OF CURB / CONCRETE
3.W.	BOTH WAYS	F.S.	FULL SIZE	OPP.	OPPOSITE	TOL. T.O.S.	TOLERANCE TOP OF STEEL / SLAB
B&B	BALLED AND BURLAPPED	FTG. FT.	FOOTING FOOT / FEET	OPQ. OVN	OPAQUE OVEN	T.O.S.S.	TOP OF STRUCTURAL SLAB
B-B	BACK TO BACK	furn.	FURNISH	ORD	OVERFLOW ROOF DRAIN	T.O.W.	TOP OF WALL
С		FURR.	FURRED / FURRING	O.S.	OVERFLOW SCUPPER	t.p.d. trans.	TOILET PAPER DISPENSER TRANSFER
CAB.	CABINET	F.V. F.V.C.	FIELD VERIFY FIRE VALVE CABINET	O/A	OUTSIDE AIR	TRZO.	TERRAZZO
CB. CCTV.	CATCH BASIN CLOSED CIRCUIT TELEVISION	F.W.C.	FABRIC WALL COVERING			T	TREAD
CEM.	CEMENT	G				T&G T.S.	TONGE & GROOVE TUBE STEEL
CER.	CERAMIC	GALV.	GALVANIZED	P	D.A. DTITLO.A.	T.T.C.	TELEPHONE TERMINAL CABINET
CFMF CIP.	COLD FORMED METAL FRAMING CAST IN PLACE	GAL.	GALLON	PART. PCF	PARTITION POUNDS PER CUBIC FOOT	TV TYP.	TELEVISION
C.I.	CAST IRON	GA. GC.	GAUGE GENERAL CONTRACTOR	PCP	PORTLAND CEMENT PLASTER	ITP.	TYPICAL
CIR.	CIRCLE	GD.	GUARD	PCT PED.	PORCELAIN CERAMIC TILE PEDESTAL		
CJ. CKBD.	CONTROL JOINT CHALK BOARD	GEN. G.I.	GENERAL GALVANIZED IRON	PERF.	PERFORATED	U	
CLG.	CEILING	G.I. GL.	GLASS / GLAZING	P.G.	PLATE GLASS	UL	UNDERWRITERS LABORATORY
CLG. HT. CLR.	CEILING HEIGHT CLEAR(ANCE)	GMP.	GUARANTEED MAXIMUM PRICE	PL. PLAST.	PLATE PLASTER	U.N.O. UR.	UNLESS NOTED OTHERWISE URINAL
CL.	CLOSET	GR. GYP.	GRADE / GRADING GYPSUM	PLAS.	PLASTIC	UK.	URINAL
	CENTIMETER	GIF.	GTF30M	PLF	POUNDS PER LINEAR FOOT	V	
CMU. CNTR.	CONCRETE MASONRY UNIT COUNTER	Н		PLBG. PLYWD.	PLUMBING PLYWOOD	V VAC.	VACUUM
COL.	COLUMN	HB H.C.	HOSE BIBB HOLLOW CORE	PNL.	PANEL	V.C.T.	VINYL COMPOSITION TILE
	. COMPRESSIBLE	HDCP.	HANDICAPPED	POL.	POLISHED	VERT.	VERTICAL
COMP. CONC.	COMPOSITION CONCRETE	HDWD.	HARDWOOD	PRKG. PR.	PARKING PAIR	VEST. V.W.C.	VESTIBULE VINYL WALL COVERING
COND.	CONDITION	HDWR. HD.	HARDWARE HEAD	PSF	POUNDS PER SQUARE FOOT		
CONF. CONST.	CONFERENCE CONSTRUCTION	H.F.S.	HALF FULL-SIZE	PSI PTD.	POUNDS PER SQUARE INCH PAINTED	W WC	WATER CLOSET
CONTR.	CONTRACTOR	H.M.	HOLLOW METAL	P.V.C.	POLYVINYL CHLORIDE	WDW.	WINDOW
CONT.	CONTINUOUS	HORIZ. HP	HORIZONTAL HORSEPOWER	PVG.	PAVING	WD.	WOOD
CORRU. CORR.	CORRUGATED CORRIDOR	HR	HOUR	PVMT. P.L.	PAVEMENT PROPERTY LINE	WF WH	WIDE FLANGE WALL-HUNG
CG.	CORNER GUARD	HT. HVAC	HEIGHT HEATING / VENTILATING /	P.LAM.	PLASTIC LAMINATE	W.I.	WROUGHT IRON
CSMT.	CASEMENT	пуас	AIR CONDITIONING	P/C	PRECAST	WP.	WATERPROOF(ING)
CTR. CTSK	CENTER COUNTERSUNK	HW	HOT WATER	PFP	PREFINISHED PANEL	WR. WT.	WATER RESISTENT WEIGHT
C.T.	CERAMIC TILE	HYD.	HYDRANT			W.W.F.	WELDED WIRE FABRIC
CU. FT.	CUBIC FOOT (FEET)			Q		W.P.	WORK POINT
CU. YD. CW.	CUBIC YARD COLD/CHILLED WATER	1	INICIDE DIALIETED	QT	QUARRY TILE	W.W. W.W.X.	WARM WHITE WARM WHITE DELUXE
C-C.	CENTER TO CENTER	I.D. INCAND.	INSIDE DIAMETER INCANDESCENT	R		W/	WITH
C.O.	CASED OPENING	INCL.	INCLUDE(D)	RCP	REFLECTED CEILING PLAN	W/I W/O	WITHIN WITHOUT
C.O.A. C.W.	CITY OF AUSTIN COOL WHITE	INFO.	INFORMATION	R.C.P.	REINFORCED CONCRETE PIPE	W/O	WIIHOUI
C.W.X.	COOL WHITE DELUXE	insul. Int.	Insulation Interior	RD REBAR	ROOF DRAIN	X	
D		IN	INCH(ES)	RECEPT.	REINFORCING BAR RECEPTION	XFMR.	TRANSFORMER
D DBL.	DOUBLE	I.P.S.	INSIDE PIPE SIZE	RECEP.	RECEPTICLE		
DEFL.	DEFLECTION	J		RECOM.	RECOMMENDATION RECESSED	SYMBO	
DEPT.	DEPARTMENT	JAN 121	JANITOR	REC. REF.	RECESSED REFRIGERATOR	¢.	CENTERLINE
OF. O.H.	DRINKING FOUNTAIN DOUBLE-HUNG	JST. JT.	TZIOL TMIOL	REG.	REGULATION	@	AT
DIAG.	DIAGONAL	L		REINF.	REINFORCED	[CHANNEL
DIA.	DIAMETER		LAMINATED	REQ'D. RES.	REQUIRED RESILIENT	/	ROUND/DIAMETER
DIM. DISC.	DIMENSION DISCONNECT	LAM. LAV.	LAMINATED LAVATORY	RET.	RETURN	, D	
DISP.	DISPENSER	LGTH.	LENGTH	REV.	REVERSE / REVISION	PL	PLATE
D.L. DMPFG.	DEAD LOAD	LH LV.	LEFT-HAND LEVEL	RE RFG.	REFER TO ROOFING	\triangle	ANGLE
DMPFG. DN.	DAMPPROOFING DOWN	LV. LIN.	LEVEL LINEAR	RH	RIGHT-HAND	&	AND
	DOOR	LL	LIVE LOAD	R	RISER	/	PER
DR. DS.	DOWNSPOUT	LT.	LIGHT	RM	ROOM	,	I LIX

± PLUS OR MINUS

SQUARE

RADIUS

R.O.W. RIGHT OF WAY

ROUGH OPENING

RETURN AIR GRILLE

RETURN AIR

R.O.

R/AG

R/A

DTL.

DWC.

DWG.

DWR.

DRYWALL FURRING CHANNEL

DETAIL

DRAWING

DRAWER

D. / d. DEEP / DEPTH


LOUVER

LIGHT-WEIGHT

LVR.

SECTION		ELEVATION
4 4 4	CONCRETE	
	PRECAST CONCRETE	
	CMU	
	BRICK	
	CAST/CUT STONE	
	natural stone	
	FINISHED WOOD	
	METAL LATH & PLASTER	
	CERAMIC/QUARRY TILE	
	GLASS/MIRROR	
	STEEL	
<u></u>	ALUMINUM	
	BRASS/BRONZE	
	GRADE/EARTH	
	GRAVEL	
	SAND	
	CONT. WOOD BLOCKING	
	DISCONT. WOOD SHIM	
	PLYWOOD (LOW & HIGH D	PETAIL)
	SPRAYED FIREPROOFING	
	BATT/BLANKET INSUL.	
	RIGID INSUL.	
	ROOF DECK INSUL.	
	GYPSUM SHEATHING	
	GYPSUM WALLBOARD	
	BACKER ROD & SEALANT	
	JOINT FILLER	
	ACOUS. CEILING	
	CARPET	

SYMBOLS

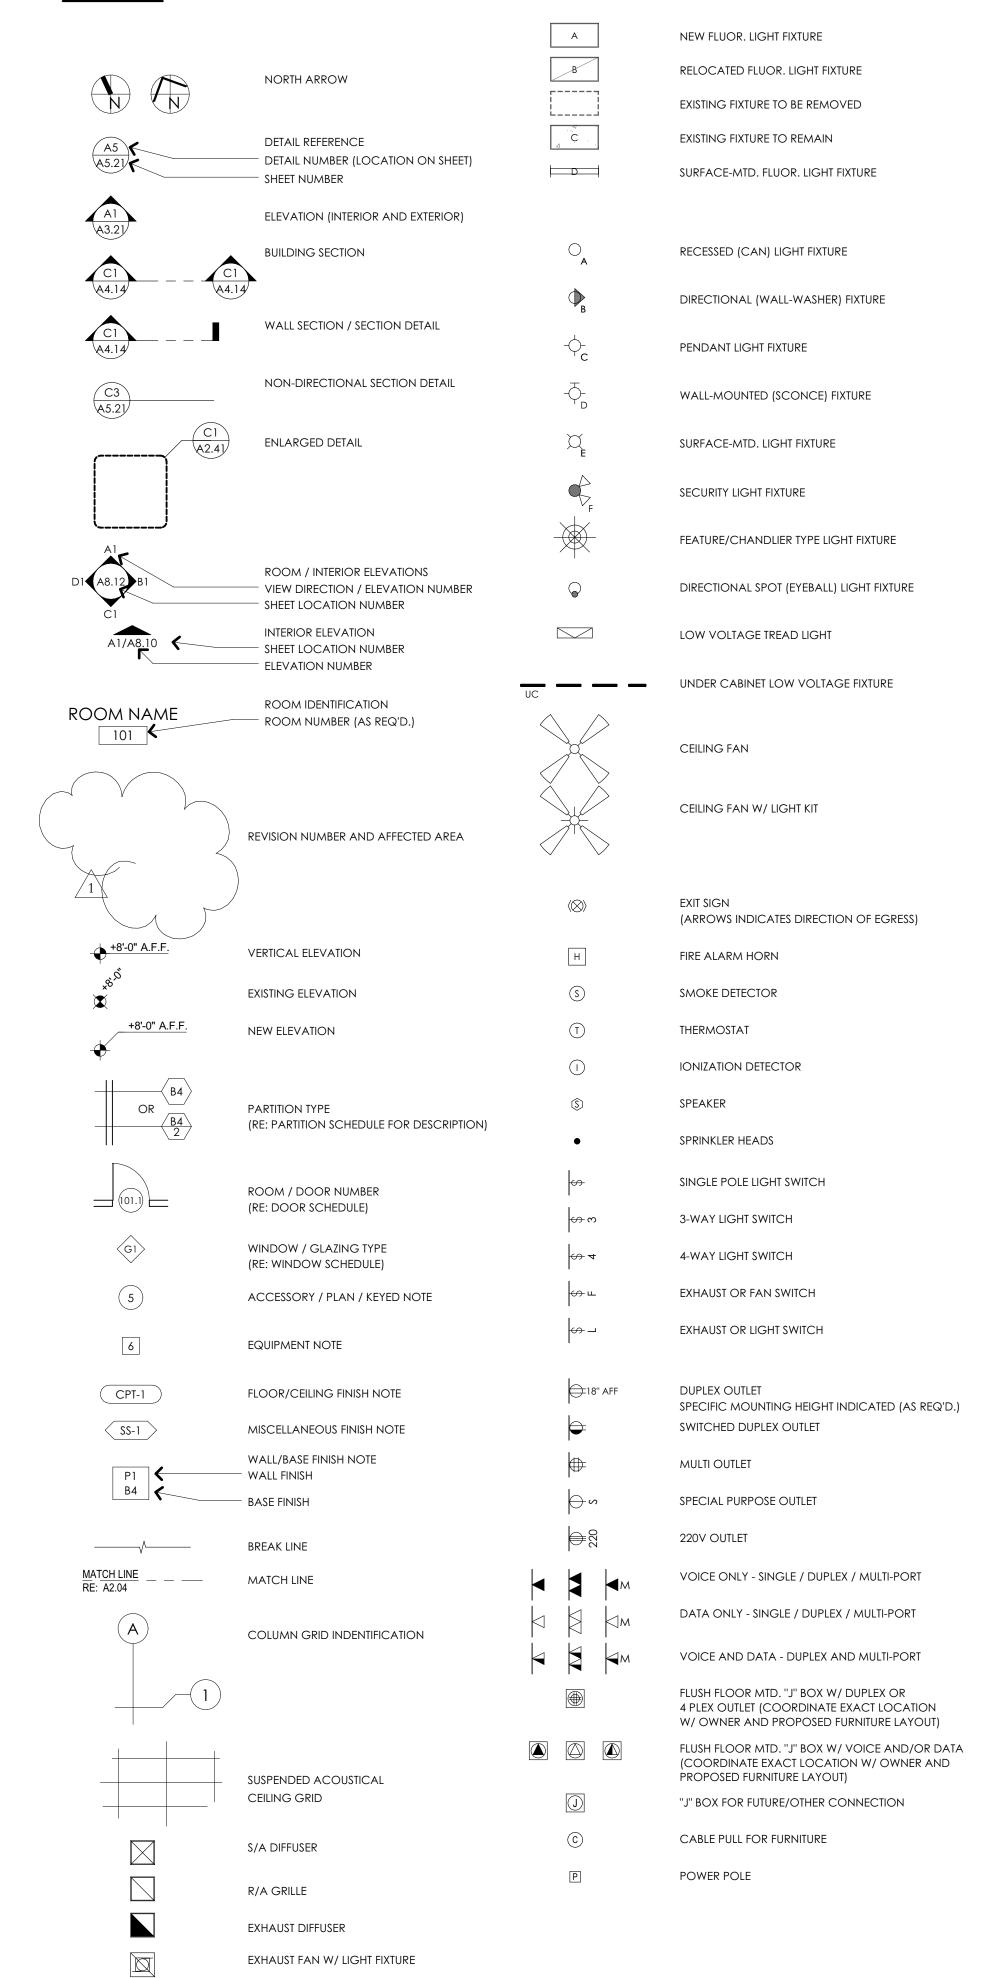

EXHAUST FAN W/O LIGHT FIXTURE



FELLNER 804 CANYON WEST LAKE HII DO NOT SCALE DRAWING

SEAL

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FOR CONSTRUCTION

restrictions.


DRAWING TITLE: ARCHITECTURAL NOTES

SCALE: AS NOTED

SCALES ARE 50% OF NOTED WHEN PRINTED ON 11 X 17 PAPER

DATE: 6/19/2025

SHEET NUMBER:

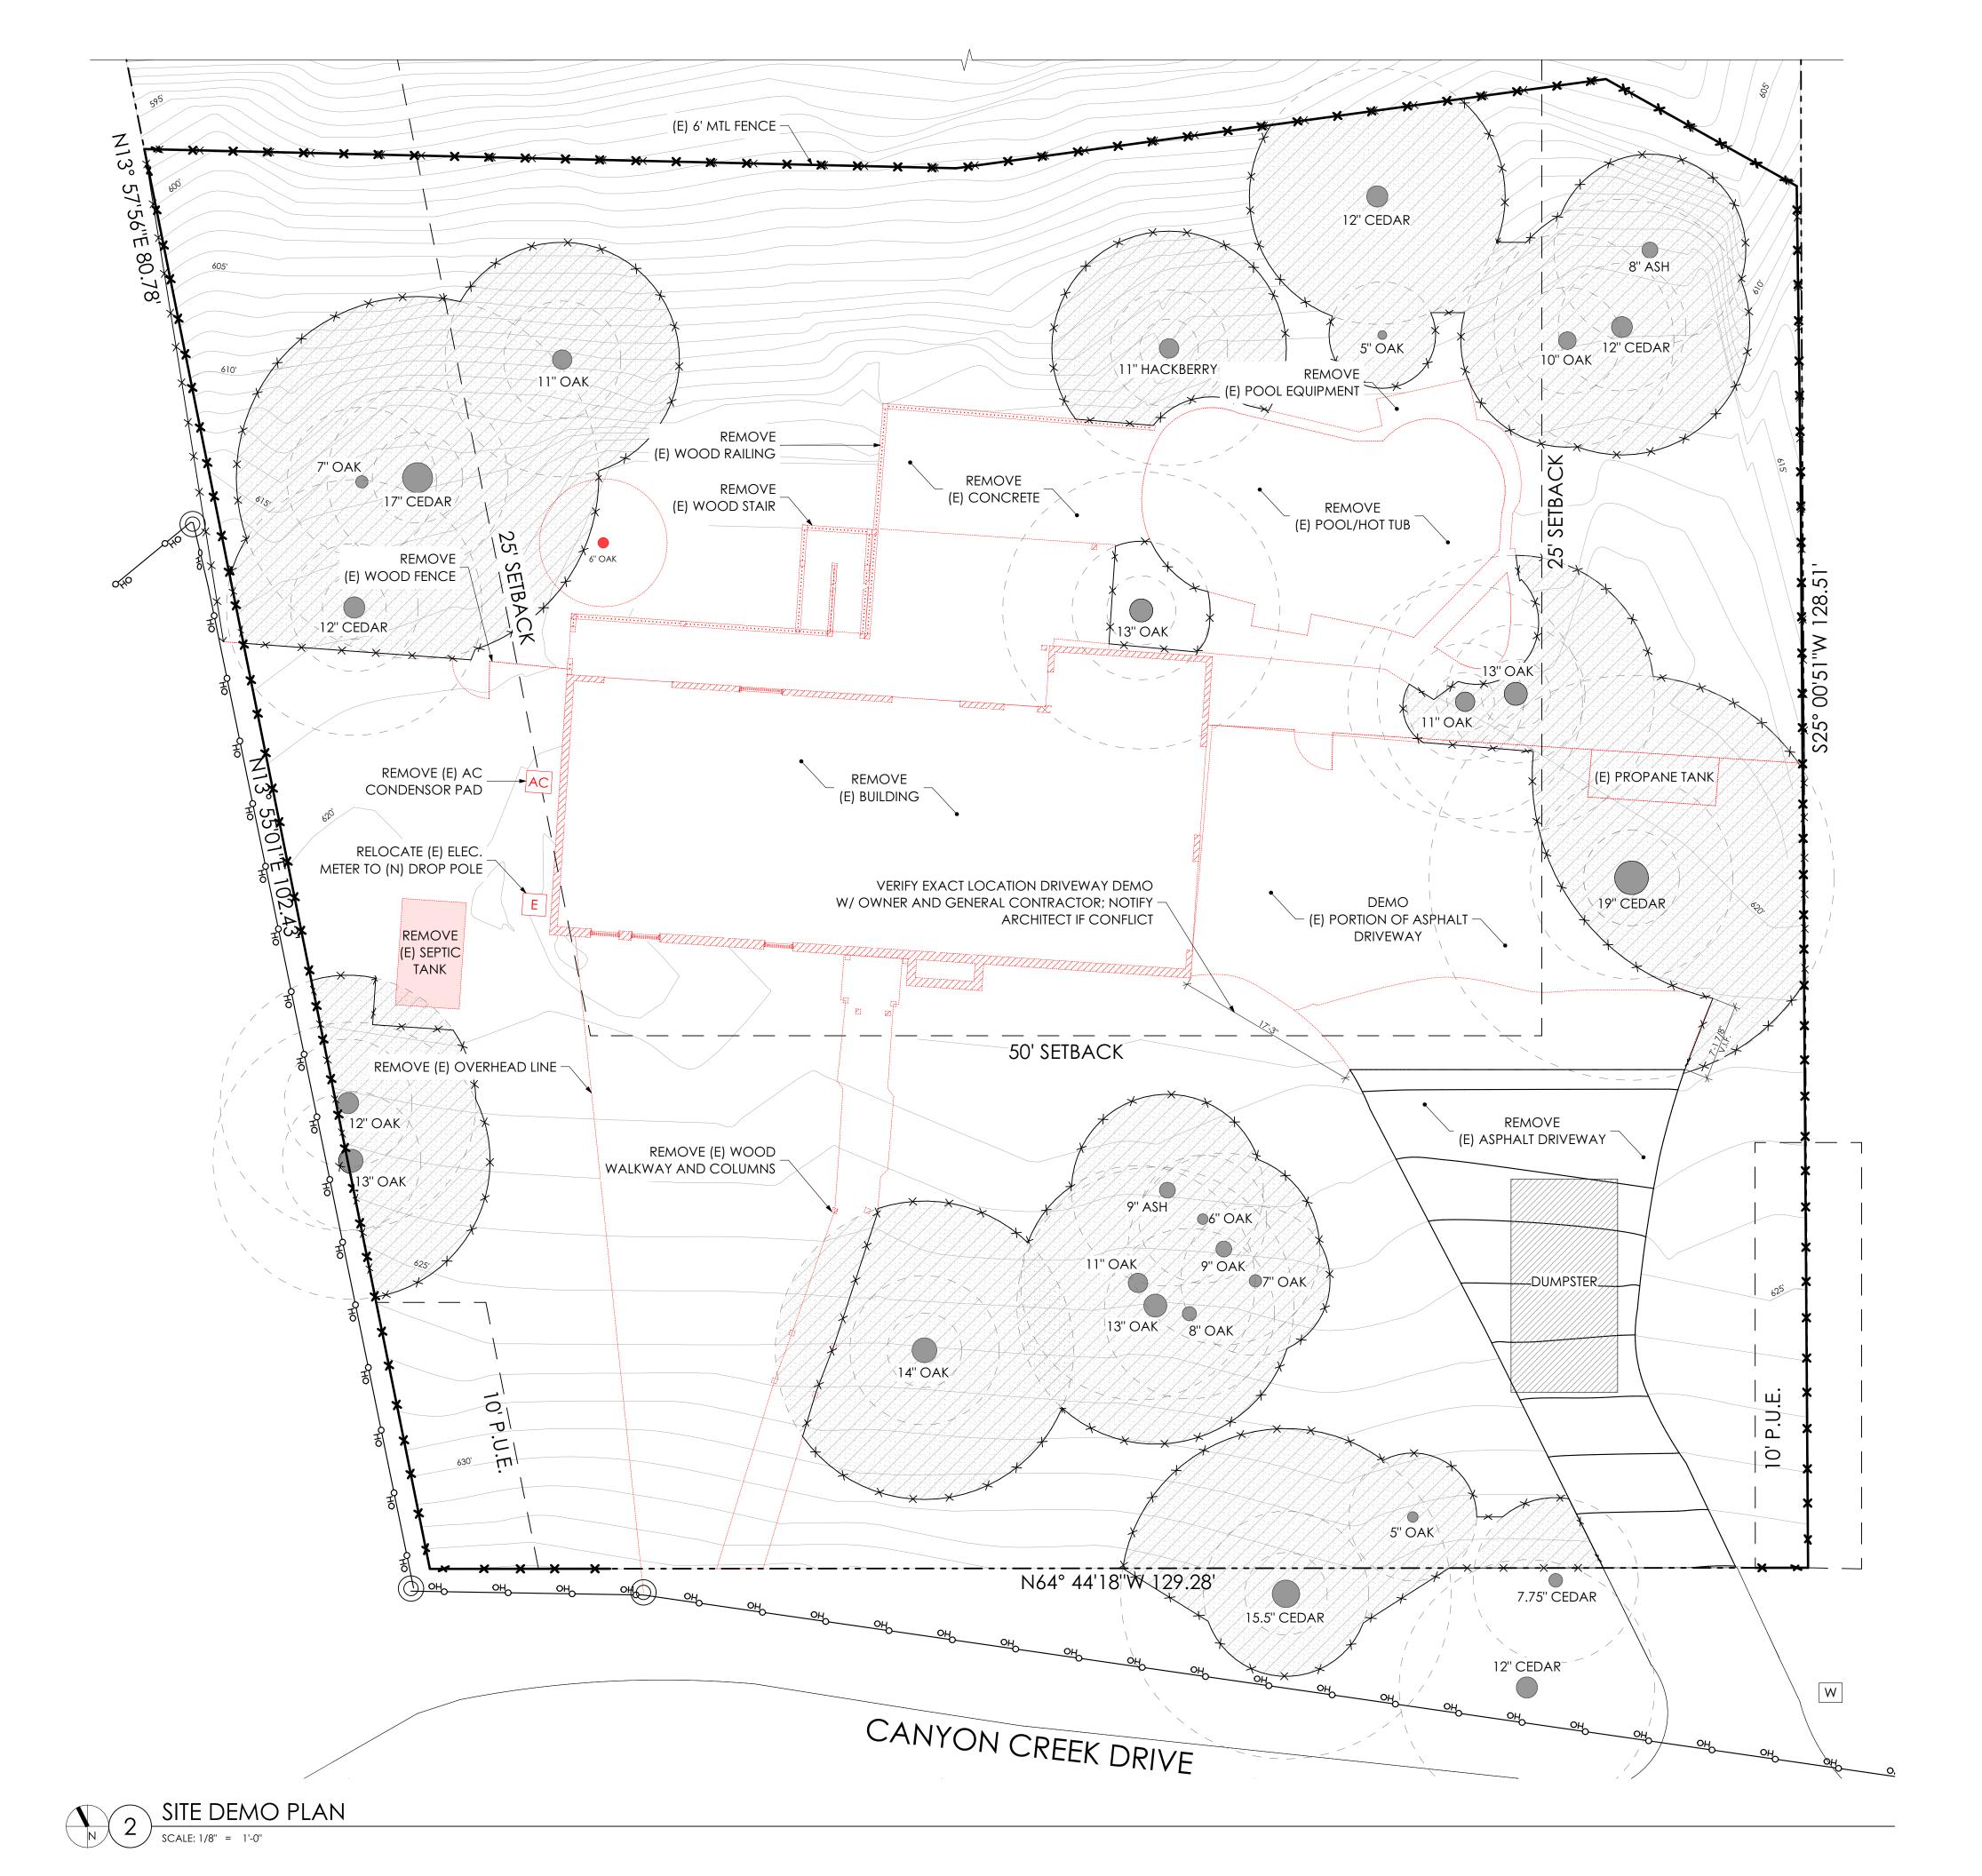

SYMBOL KEY:

EXISTING DEMO MULCH GAS METER

G

ELECTRIC METER

WATER METER

AC A/C UNIT

PROPERTY LINE ______


SETBACK **EASEMEN**1

UTILITY POLE

EROSION FENCE

PROTECTED TREE

FENCE

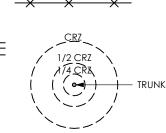

GENERAL NOTES:

1. TREE PROTECTION FENCING AND MULCH SHALL BE INSTALLED AT APPLICABLE TREES WITHIN THE LIMITS OF CONSTRUCTION AS NOTED. FENCING SHALL PROTECT THE ENTIRE CRITICAL ROOT ZONE (CRZ) AREA WHERE POSSIBLE. FENCING IS REQUIRED TO BE CHAIN-LINK MESH AT A MINIMUM HEIGHT OF 5 FT. A 6 IN LAYER OF MULCH WITHIN THE ENTIRE AVAILABLE ROOT ZONE AREA IS REQUIRED FOR TREES WHICH HAVE ANY DISTURBANCE INDICATED WITHIN ANY PORTION OF THE CRITICAL ROOT ZONE.


2. CONTRACTOR TO REVIEW PLAN FOR SITE ACCESS AND TREE PROTECTION WITH ARCHITECT PRIOR TO STARTING CONSTRUCTION.

3. NO CUT OR FILL 4" OR GREATER WITHIN THE 1/2 CRZ OF PROTECTED TREES. NO IMPACT ALLOWED IN THE 1/4 CRZ.

4. REFER TO SEPTIC DESIGN FOR INSTRUCTION ON REMOVING EXISTING SEPTIC SYSTEM

5. HAND DIGGING OR AIR SPADE SHALL BE USED FOR SOIL EXCAVATION WITHIN AREAS OF RESTRICTED ROOT ZONE WITHOUT DAMGE TO SIGNIFICANT ROOTS PER CITY OF AUSTIN **ENVIRONMENTAL CRITERIA MANUAL 3.5.2**

6. EROSION SEDIMENT CONTROL TO BE PROVIDED ALONG DOWNSLOPE OF SITE

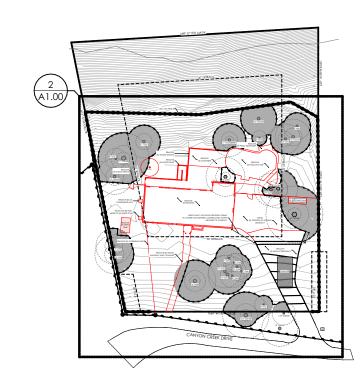





FELLNER 804 CANYON (WEST LAKE HILL DO NOT SCALE DRAWING



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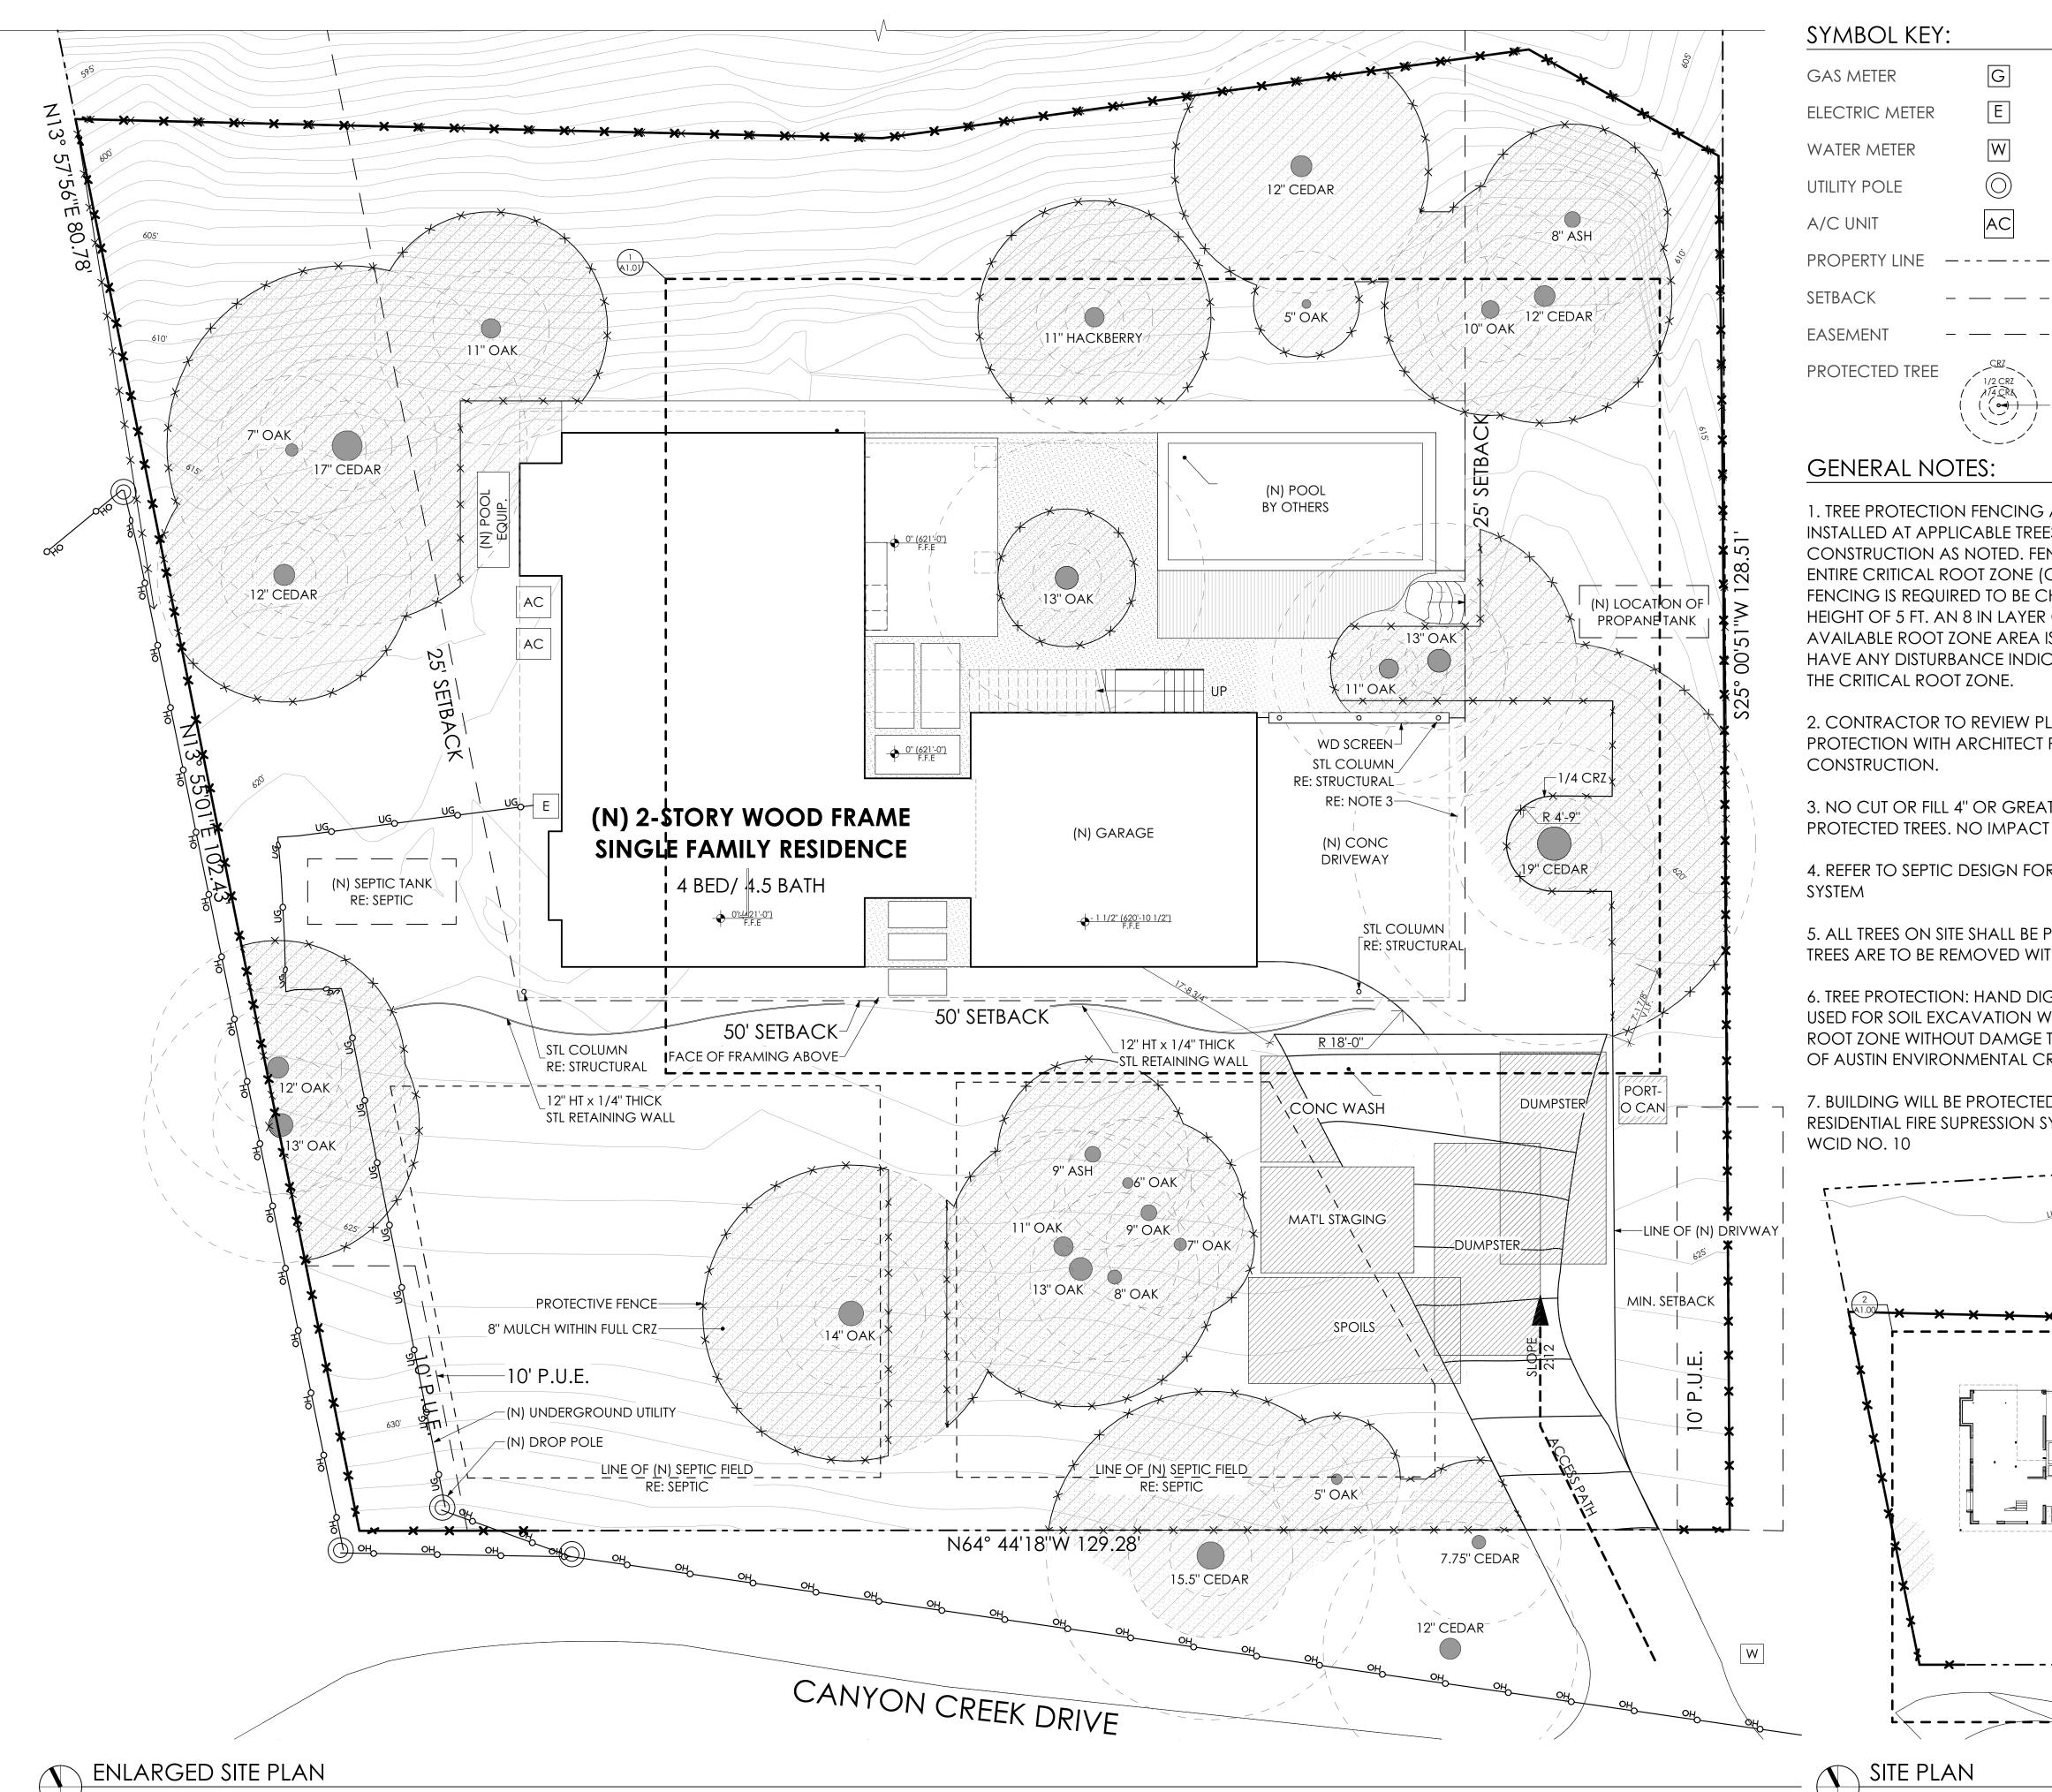
DRAWING TITLE: SITE DEMO PLAN

SCALE: AS NOTED


SCALES ARE 50% OF NOTED WHEN PRINTED ON 11 X 17 PAPER

DATE: 6/19/2025

SHEET NUMBER:



W

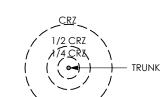

1. TREE PROTECTION FENCING AND MULCH SHALL BE INSTALLED AT APPLICABLE TREES WITHIN THE LIMITS OF CONSTRUCTION AS NOTED. FENCING SHALL PROTECT THE ENTIRE CRITICAL ROOT ZONE (CRZ) AREA WHERE POSSIBLE FENCING IS REQUIRED TO BE CHAIN-LINK MESH AT A MINIMUM HEIGHT OF 5 FT. AN 8 IN LAYER OF MULCH WITHIN THE ENTIRE AVAILABLE ROOT ZONE AREA IS REQUIRED FOR TREES WHICH HAVE ANY DISTURBANCE INDICATED WITHIN ANY PORTION OF THE CRITICAL ROOT ZONE.

2. CONTRACTOR TO REVIEW PLAN FOR SITE ACCESS AND TREE PROTECTION WITH ARCHITECT PRIOR TO STARTING


3. NO CUT OR FILL 4" OR GREATER WITHIN THE 1/2 CRZ OF PROTECTED TREES. NO IMPACT ALLOWED IN THE 1/4 CRZ.

4. REFER TO SEPTIC DESIGN FOR SIZE AND LOCATION OF NEW

5. ALL TREES ON SITE SHALL BE PRESERVED PER 22.03.305. NO TREES ARE TO BE REMOVED WITH MITIGATION

6. TREE PROTECTION: HAND DIGGING OR AIR SPADE SHALL BE USED FOR SOIL EXCAVATION WITHIN AREAS OF RESTRICTED ROOT ZONE WITHOUT DAMGE TO SIGNIFICANT ROOTS PER CITY OF AUSTIN ENVIRONMENTAL CRITERIA MANUAL 3.5.2

7. BUILDING WILL BE PROTECTED THROUGHOUT WITH RESIDENTIAL FIRE SUPRESSION SYSTEM PER TRAVIS COUNTY

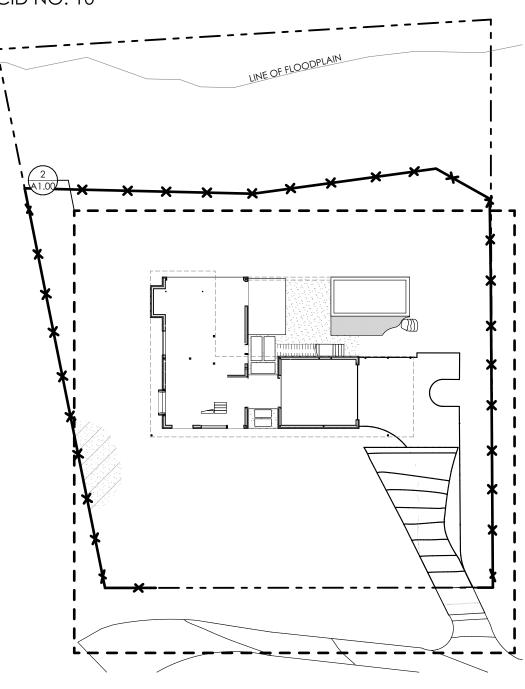

Point B Design Group 1009 W 6TH ST STE 207 AUSTIN, TX 78703 o. 512-568-9803

FELLNER 804 CANYON WEST LAKE HII

DO NOT SCALE DRAWING



SEAL

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FOR CONSTRUCTION


DRAWING TITLE: SITE PLAN

SCALE: AS NOTED

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DATE: 6/19/2025

SHEET NUMBER:

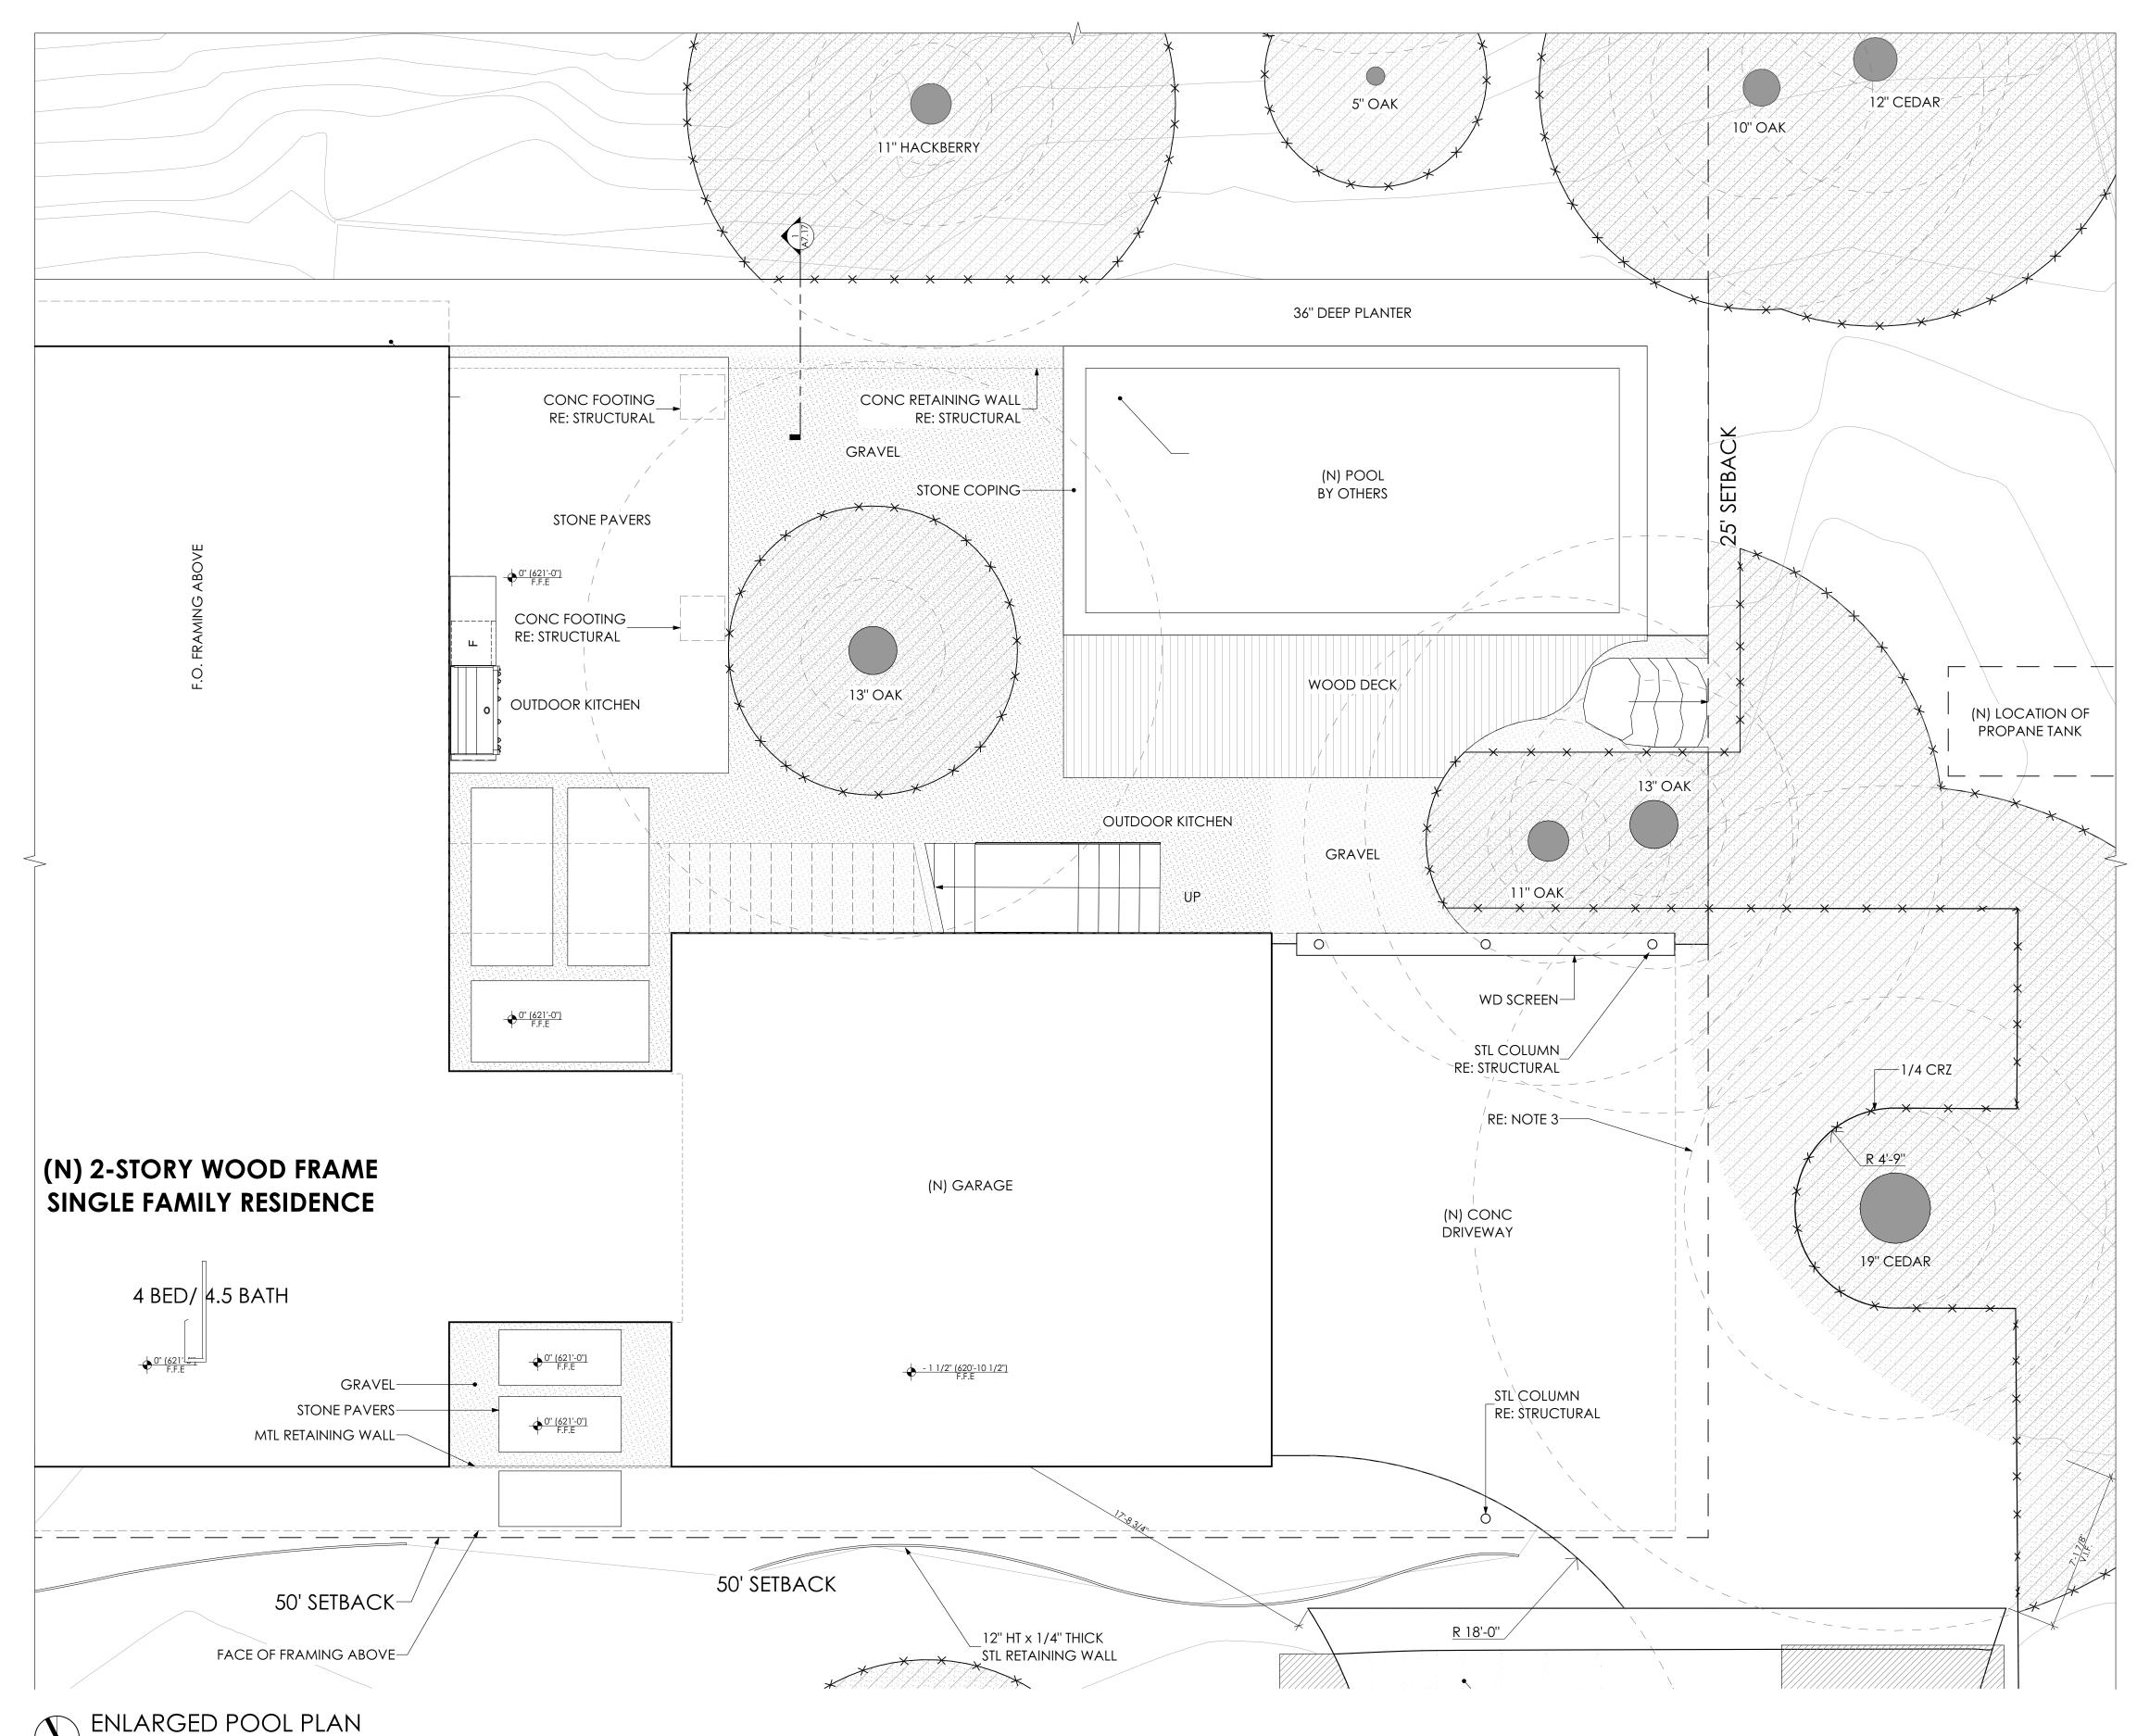

N SCALE: 1/4" = 1'-0"

SYMBOL KEY:

GAS METER

R E

G

W

ELECTRIC METER
WATER METER

UTILITY POLE

A/C UNIT AC

PROPERTY LINE

SETBACK - — —

EASEMENT

GENERAL NOTES:

1. TREE PROTECTION FENCING AND MULCH SHALL BE INSTALLED AT APPLICABLE TREES WITHIN THE LIMITS OF CONSTRUCTION AS NOTED. FENCING SHALL PROTECT THE ENTIRE CRITICAL ROOT ZONE (CRZ) AREA WHERE POSSIBLE. FENCING IS REQUIRED TO BE CHAIN-LINK MESH AT A MINIMUM HEIGHT OF 5 FT. AN 8 IN LAYER OF MULCH WITHIN THE ENTIRE AVAILABLE ROOT ZONE AREA IS REQUIRED FOR TREES WHICH HAVE ANY DISTURBANCE INDICATED WITHIN ANY PORTION OF THE CRITICAL ROOT ZONE.

2. CONTRACTOR TO REVIEW PLAN FOR SITE ACCESS AND TREE PROTECTION WITH ARCHITECT PRIOR TO STARTING CONSTRUCTION.

3. NO CUT OR FILL 4" OR GREATER WITHIN THE 1/2 CRZ OF PROTECTED TREES. NO IMPACT ALLOWED IN THE 1/4 CRZ.

4. REFER TO SEPTIC DESIGN FOR SIZE AND LOCATION OF NEW SYSTEM


5. ALL DOWNSPOUTS DIRECT WATER TO RAINWATER COLLECTION TANK. RE: A2.00 FOR DOWNSPOUT LOCATIONS

6. TREE PROTECTION: HAND DIGGING OR AIR SPADE SHALL BE USED FOR SOIL EXCAVATION WITHIN AREAS OF RESTRICTED ROOT ZONE WITHOUT DAMGE TO SIGNIFICANT ROOTS PER CITY OF AUSTIN ENVIRONMENTAL CRITERIA MANUAL 3.5.2

7. BUILDING WILL BE PROTECTED THROUGHOUT WITH RESIDENTIAL FIRE SUPRESSION SYSTEM PER TRAVIS COUNTY WCID NO. 10



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WEST LAKE HILLS TX 7874

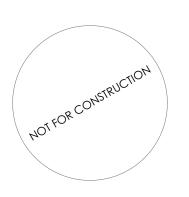

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DRAWING TITLE: SITE PLAN - POOL


SCALE: AS NOTED

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DATE: 6/19/2025

SHEET NUMBER:





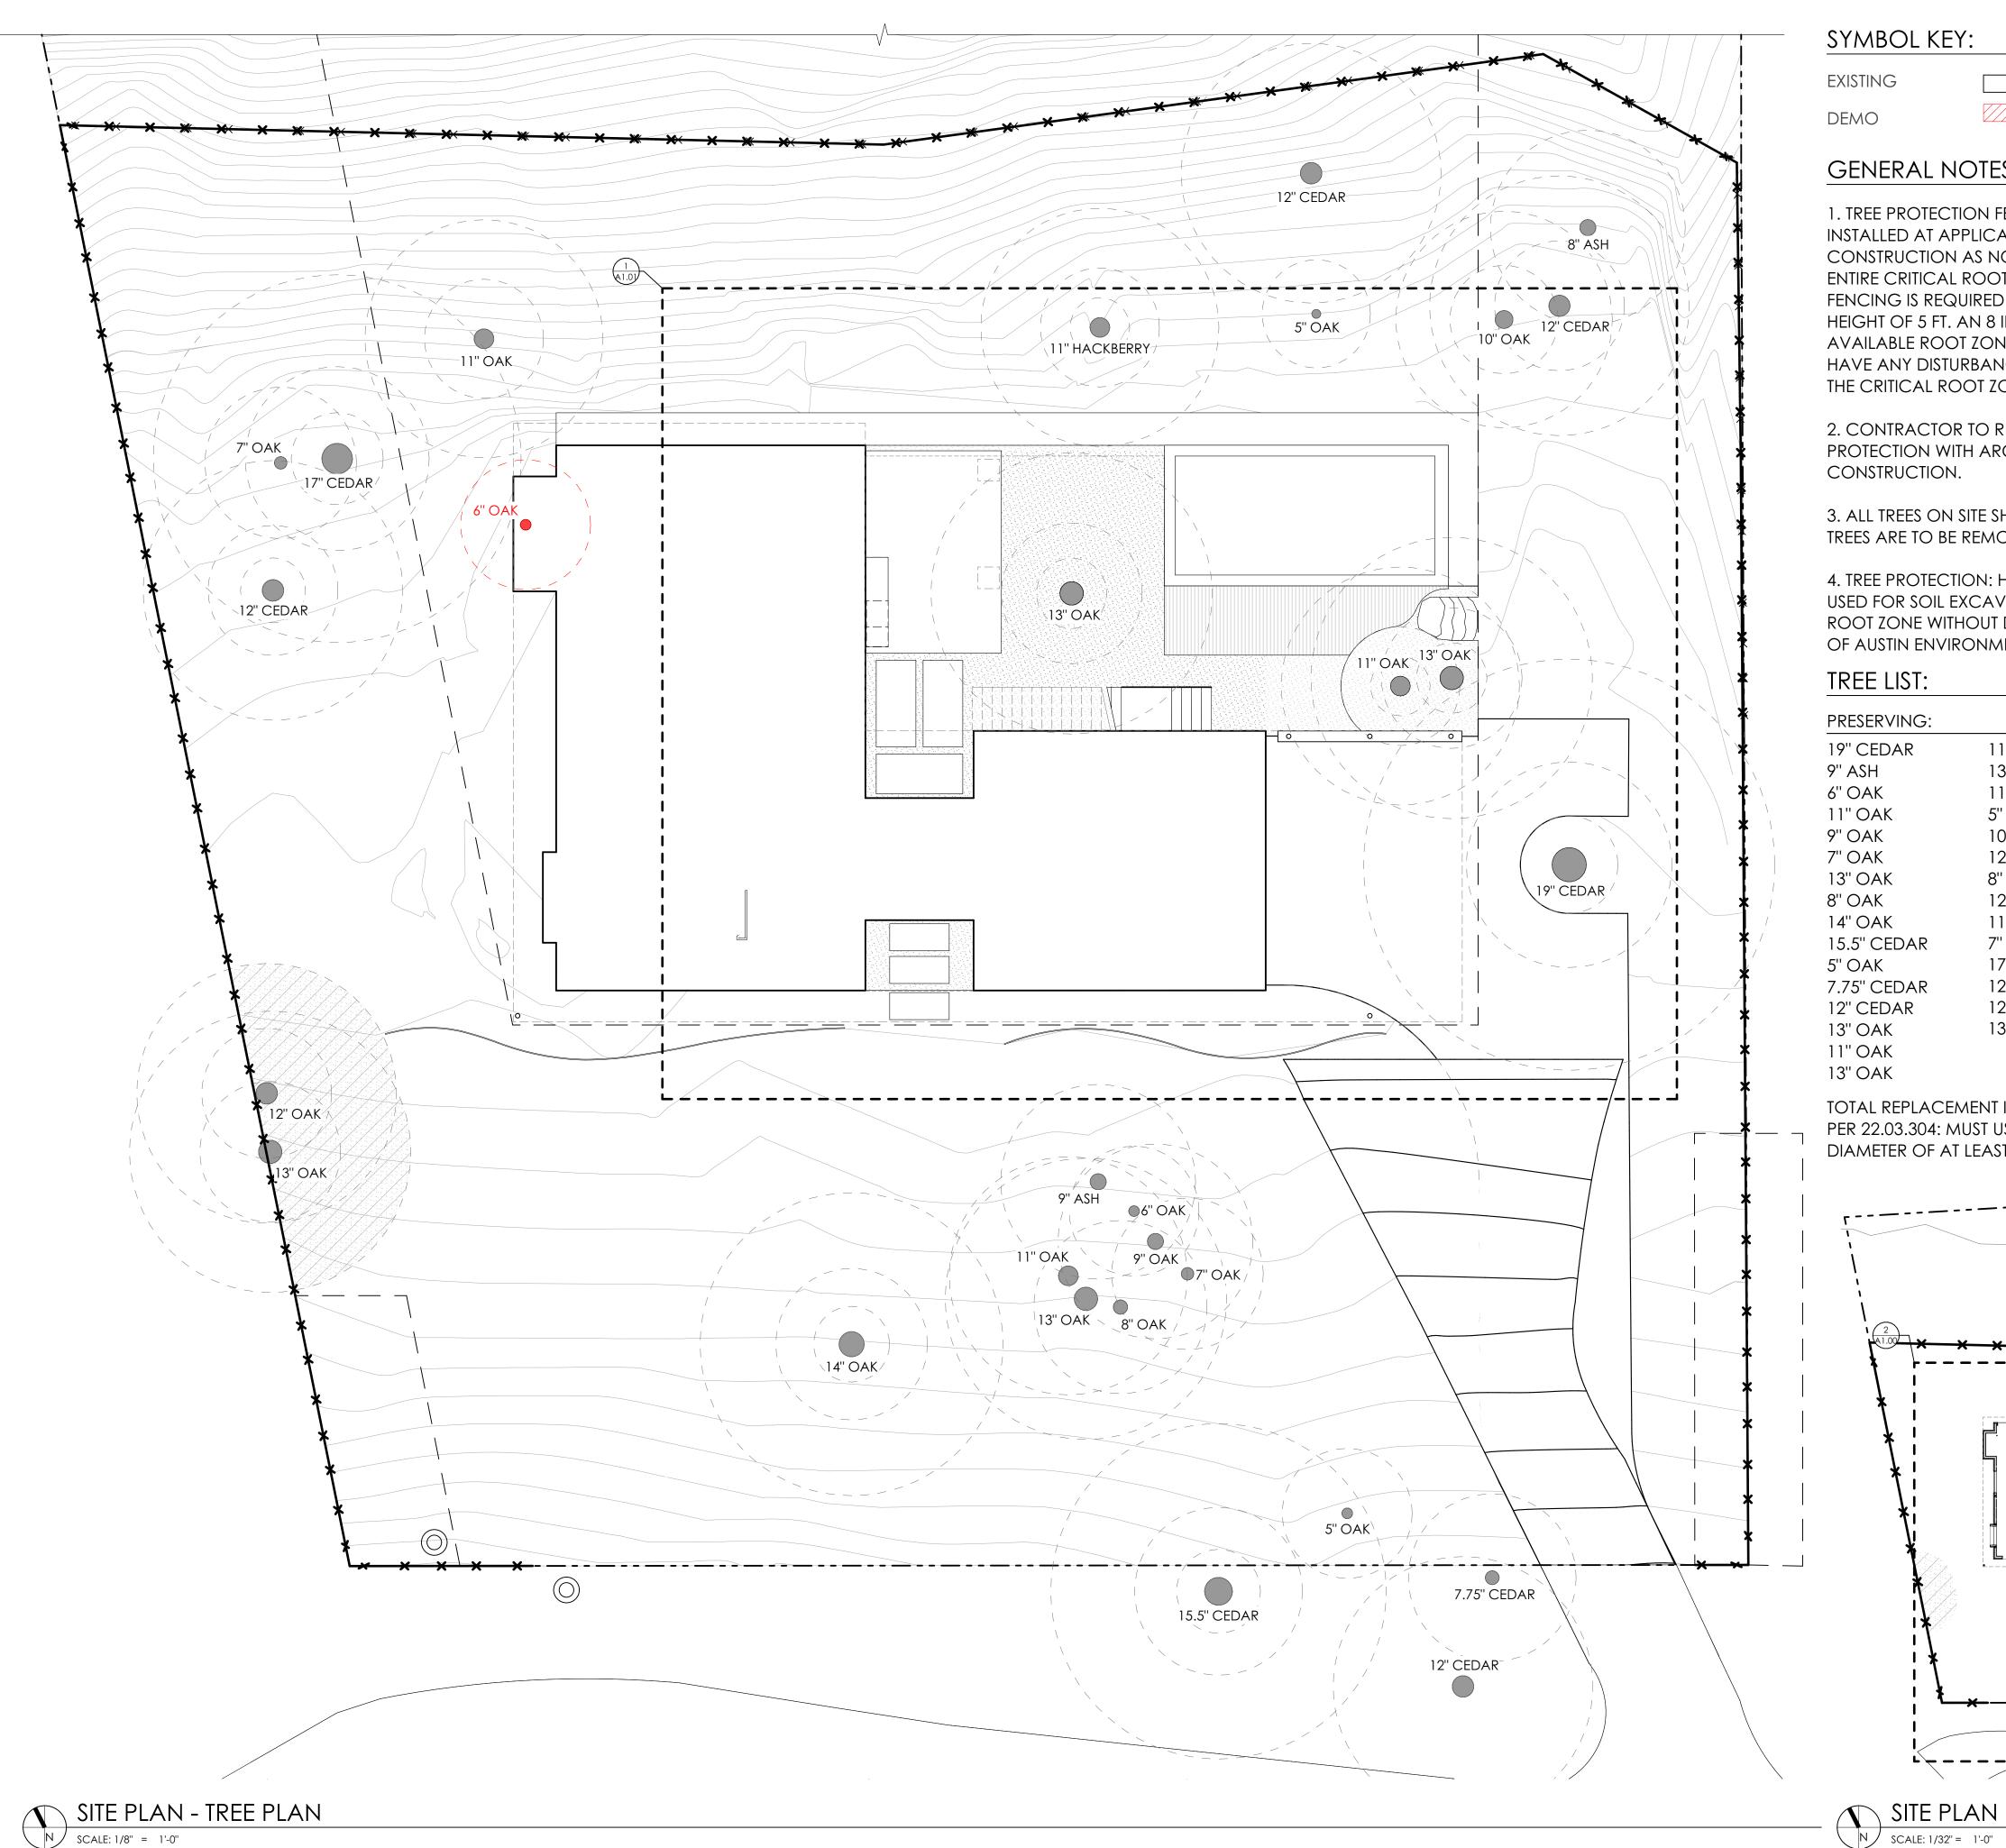

GENERAL NOTES:

1. TREE PROTECTION FENCING AND MULCH SHALL BE INSTALLED AT APPLICABLE TREES WITHIN THE LIMITS OF CONSTRUCTION AS NOTED. FENCING SHALL PROTECT THE ENTIRE CRITICAL ROOT ZONE (CRZ) AREA WHERE POSSIBLE. FENCING IS REQUIRED TO BE CHAIN-LINK MESH AT A MINIMUM HEIGHT OF 5 FT. AN 8 IN LAYER OF MULCH WITHIN THE ENTIRE AVAILABLE ROOT ZONE AREA IS REQUIRED FOR TREES WHICH HAVE ANY DISTURBANCE INDICATED WITHIN ANY PORTION OF THE CRITICAL ROOT ZONE.


2. CONTRACTOR TO REVIEW PLAN FOR SITE ACCESS AND TREE PROTECTION WITH ARCHITECT PRIOR TO STARTING CONSTRUCTION.

3. ALL TREES ON SITE SHALL BE PRESERVED PER 22.03.305. NO TREES ARE TO BE REMOVED WITH MITIGATION

4. TREE PROTECTION: HAND DIGGING OR AIR SPADE SHALL BE USED FOR SOIL EXCAVATION WITHIN AREAS OF RESTRICTED ROOT ZONE WITHOUT DAMGE TO SIGNIFICANT ROOTS PER CITY OF AUSTIN ENVIRONMENTAL CRITERIA MANUAL 3.5.2

PRESERVING:		REMOVING
19" CEDAR	11" OAK	6" OAK
9" ASH	13" OAK	
6" OAK	11" HACKBERRY	
11" OAK	5" OAK	
9" OAK	10" OAK	
7" OAK	12" CEDAR	
13" OAK	8" ASH	
8" OAK	12" CEDAR	
14" OAK	11" OAK	
15.5" CEDAR	7'' OAK	
5" OAK	17" CEDAR	
7.75" CEDAR	12" CEDAR	
12" CEDAR	12'' OAK	
13" OAK	13" OAK	
11" OAK		
13" OAK		

TOTAL REPLACEMENT INCHES = 6" x 75% = 4.5" PER 22.03.304: MUST USE REPLACEMENT TREES WITH TRUNK DIAMETER OF AT LEAST TWO (2) INCHES.

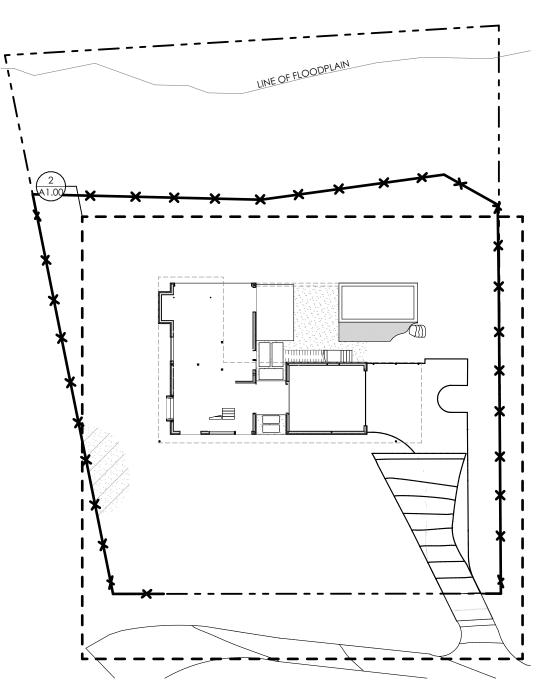

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DRAWING TITLE: SITE PLAN - TREE PLAN

SCALE: AS NOTED

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DATE: 6/19/2025

SHEET NUMBER:

N SCALE: 1/4" = 1'-0"



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FOR CONSTRUCTION

restrictions.

DRAWING TITLE: FOUNDATION PLAN


SCALE: AS NOTED

SCALES ARE 50% OF NOTED WHEN PRINTED ON 11 X 17 PAPER

DATE: 6/19/2025

SHEET NUMBER:

A2.00

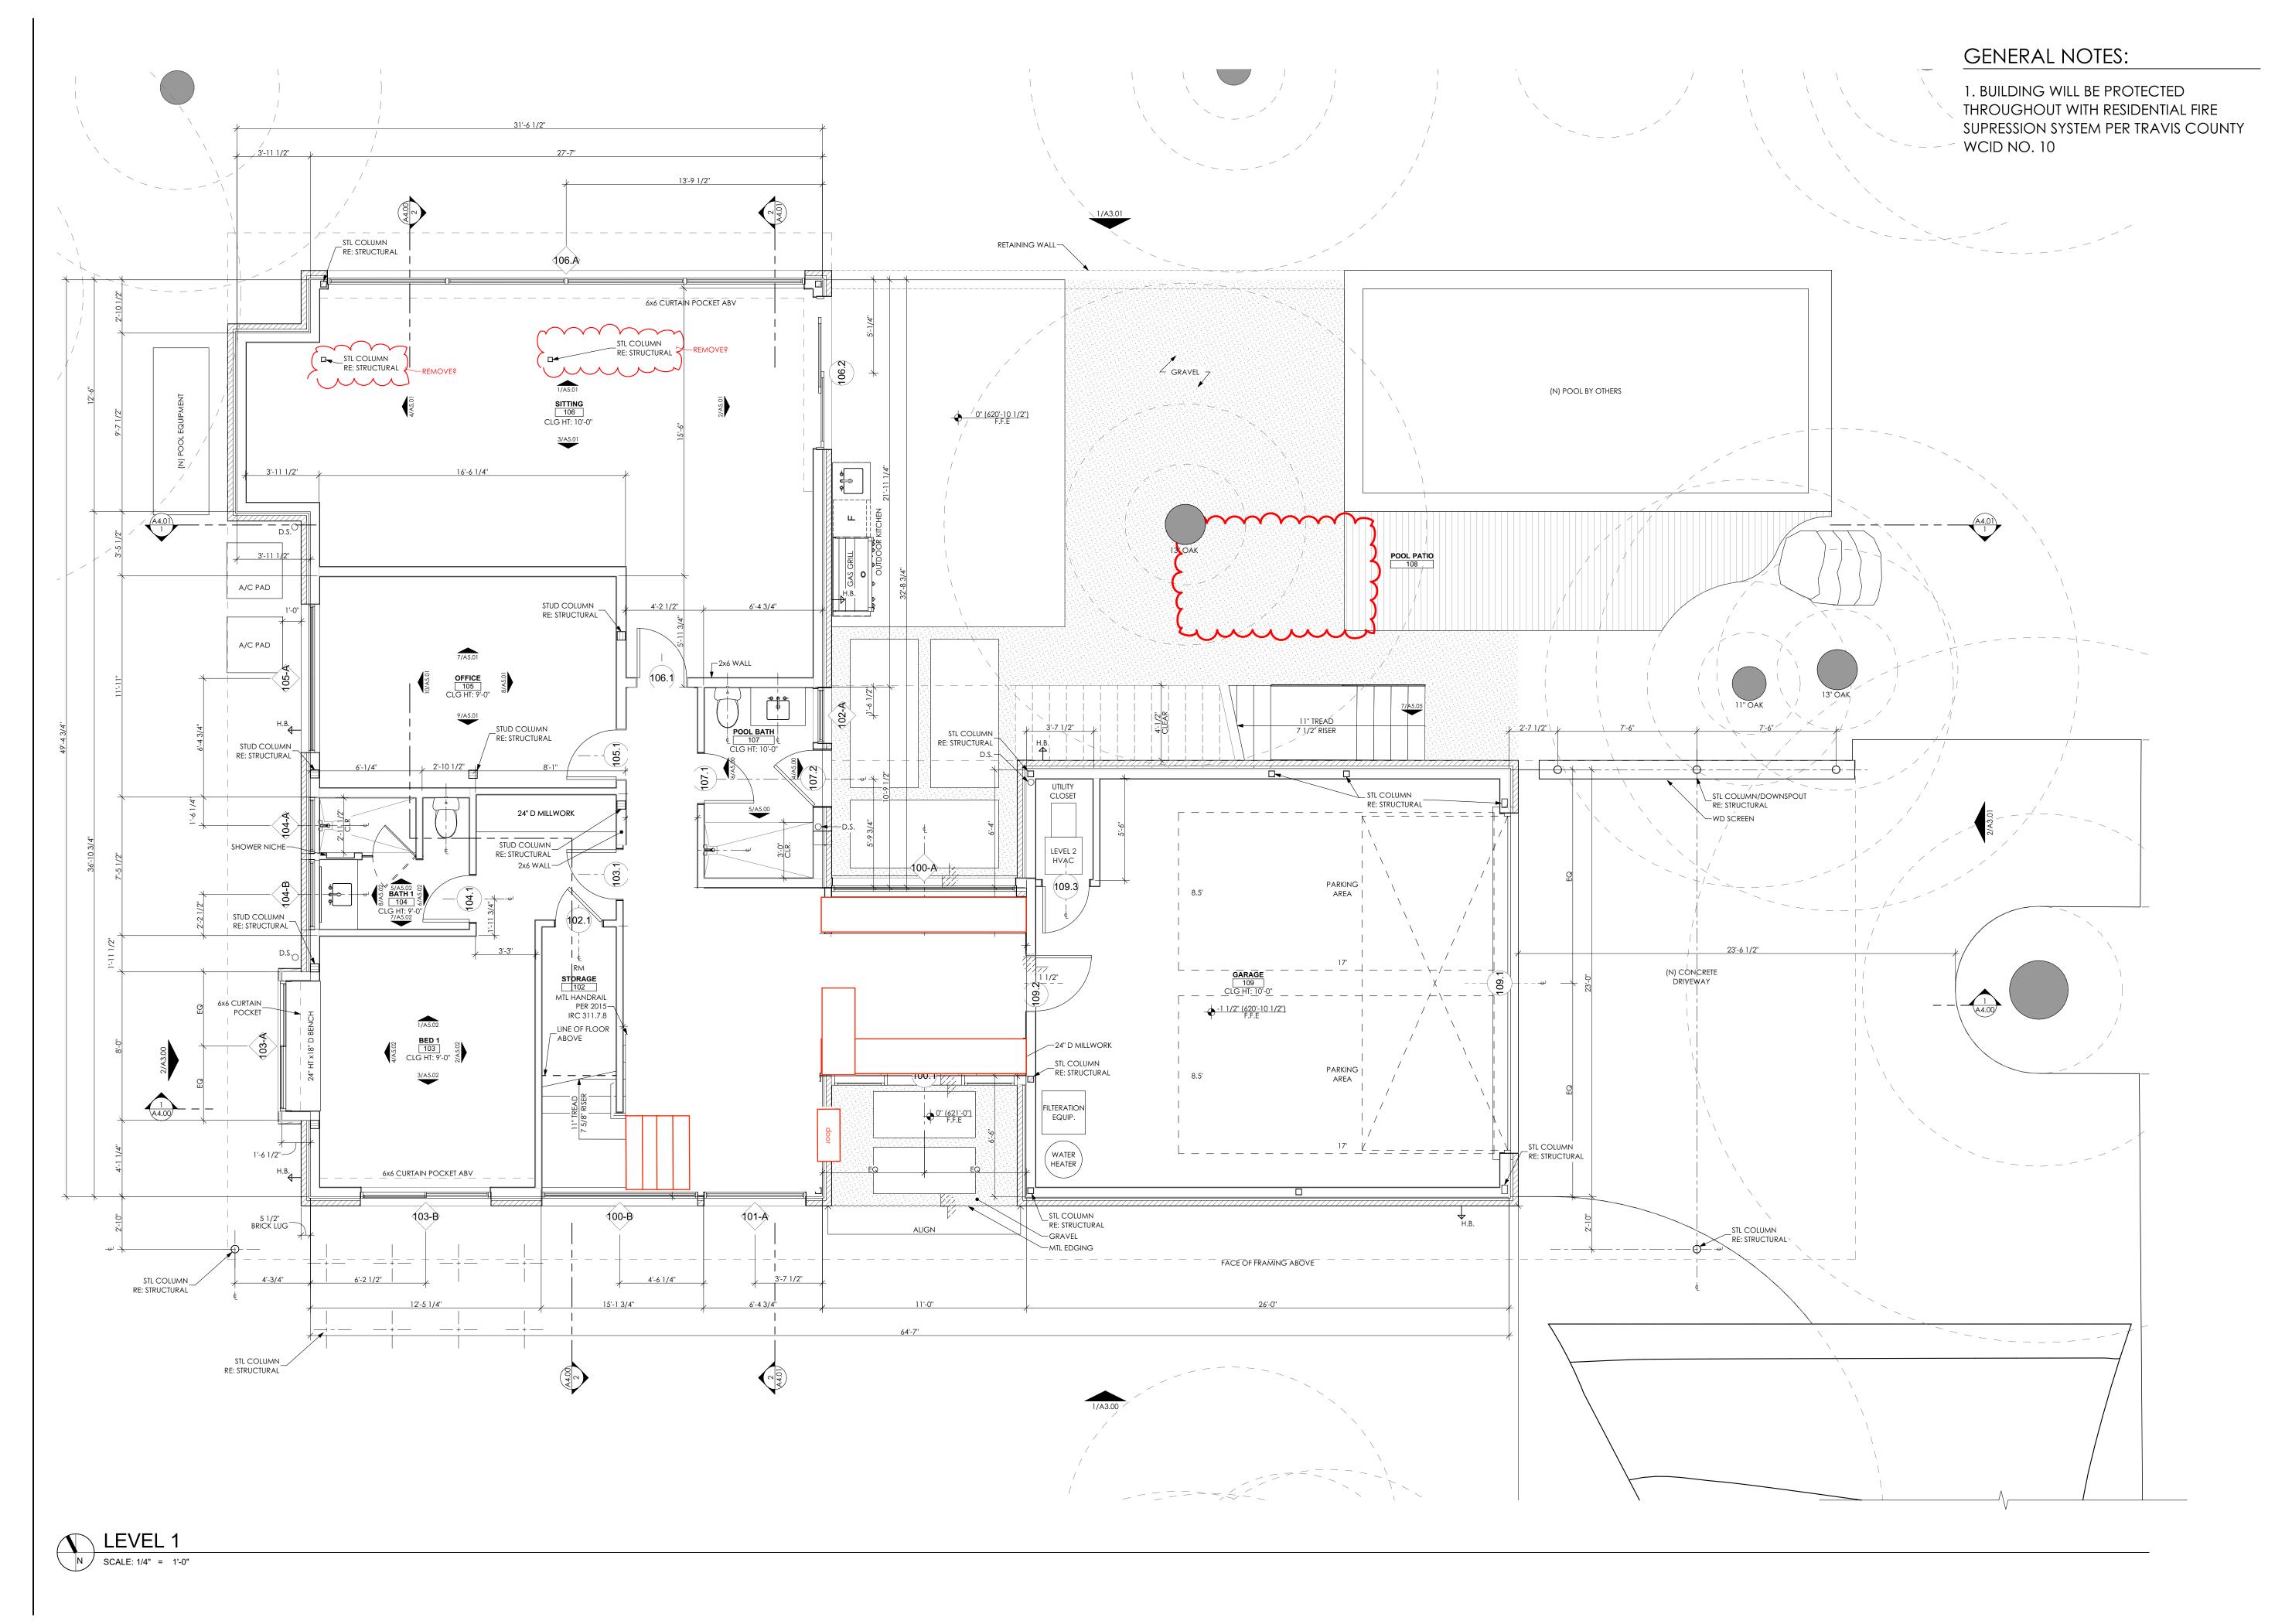



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DRAWING TITLE: FLOOR PLANS

SCALE: AS NOTED

SCALES ARE 50% OF NOTED WHEN PRINTED ON 11 X 17 PAPER

DATE: 6/19/2025


SHEET NUMBER:

A2.10

GENERAL NOTES:

1. BUILDING WILL BE PROTECTED
THROUGHOUT WITH RESIDENTIAL FIRE
SUPRESSION SYSTEM PER TRAVIS COUNTY
WCID NO. 10




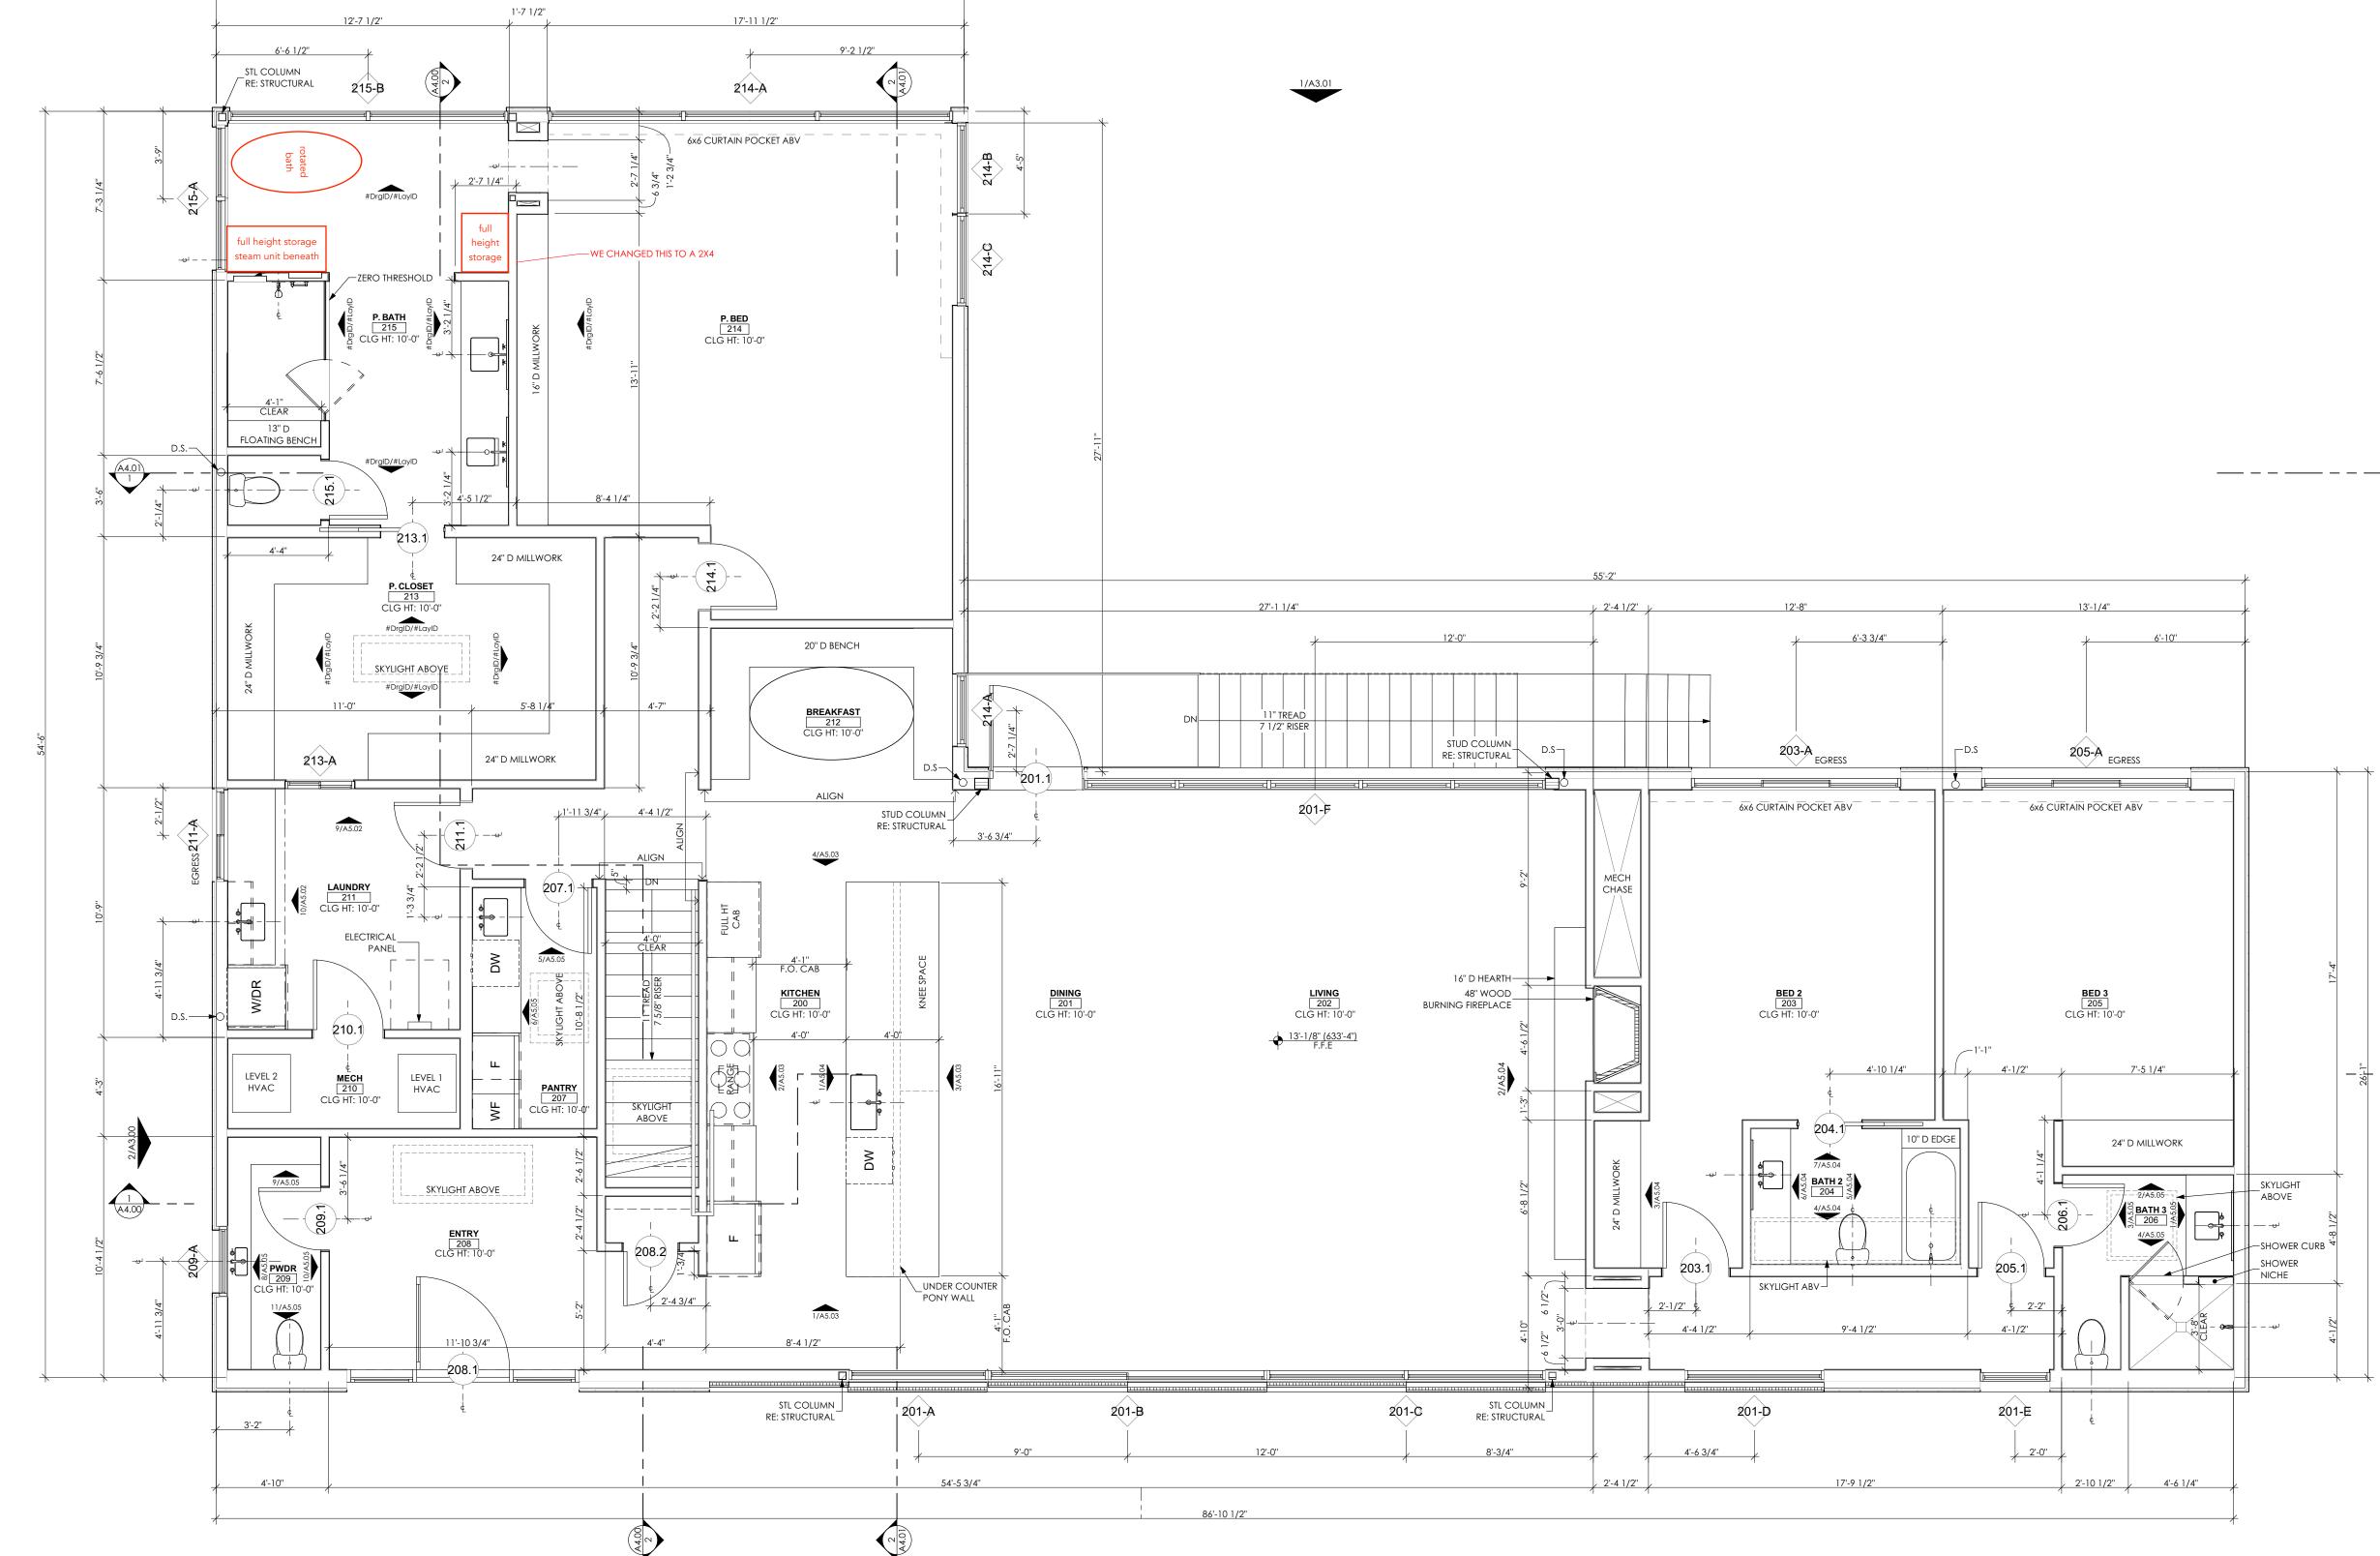

32'-2 1/2"

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DRAWING TITLE: FLOOR PLANS

SCALE: AS NOTED

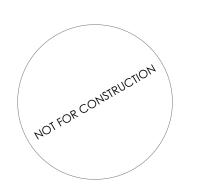SCALES ARE 50% OF NOTED WHEN PRINTED ON 11 X 17 PAPER

DATE: 6/19/2025

SHEET NUMBER:

A2.11

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FOR CONSTRUCTION

restrictions.

DRAWING TITLE: ROOF PLAN

SCALE: AS NOTED


SCALES ARE 50% OF NOTED WHEN PRINTED ON 11 X 17 PAPER


DATE: 6/19/2025

SHEET NUMBER:

A2.12



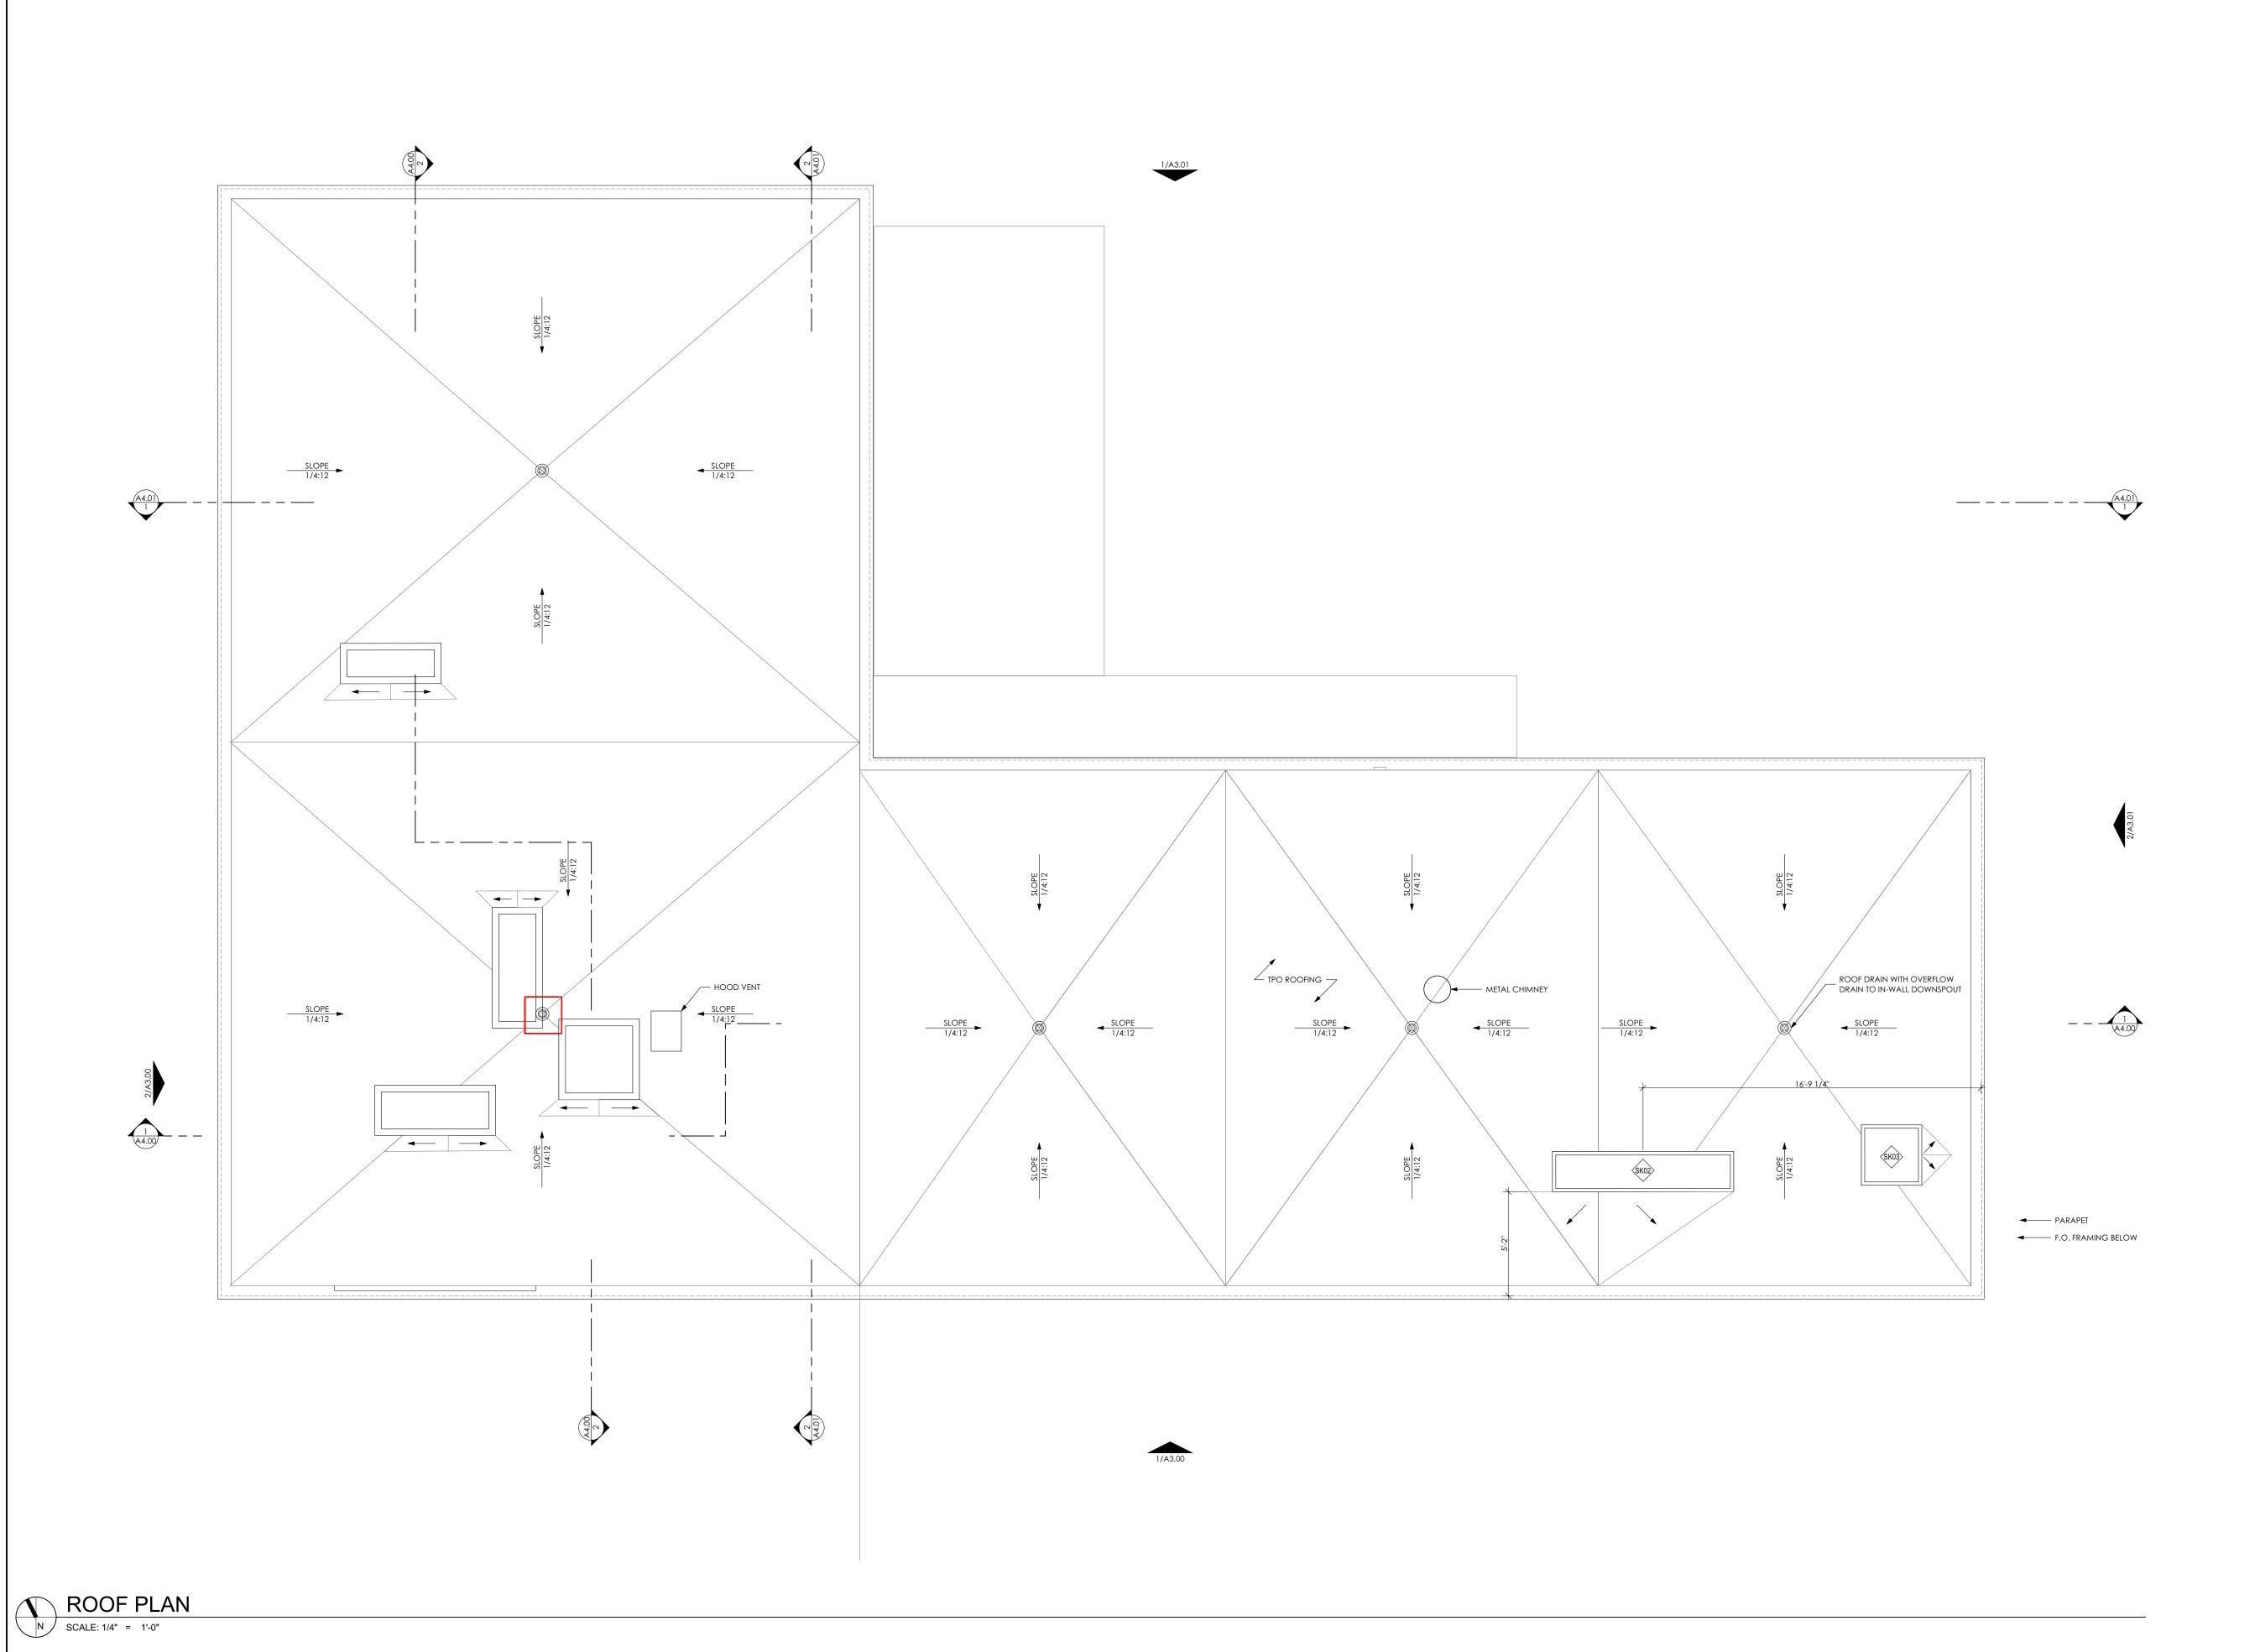

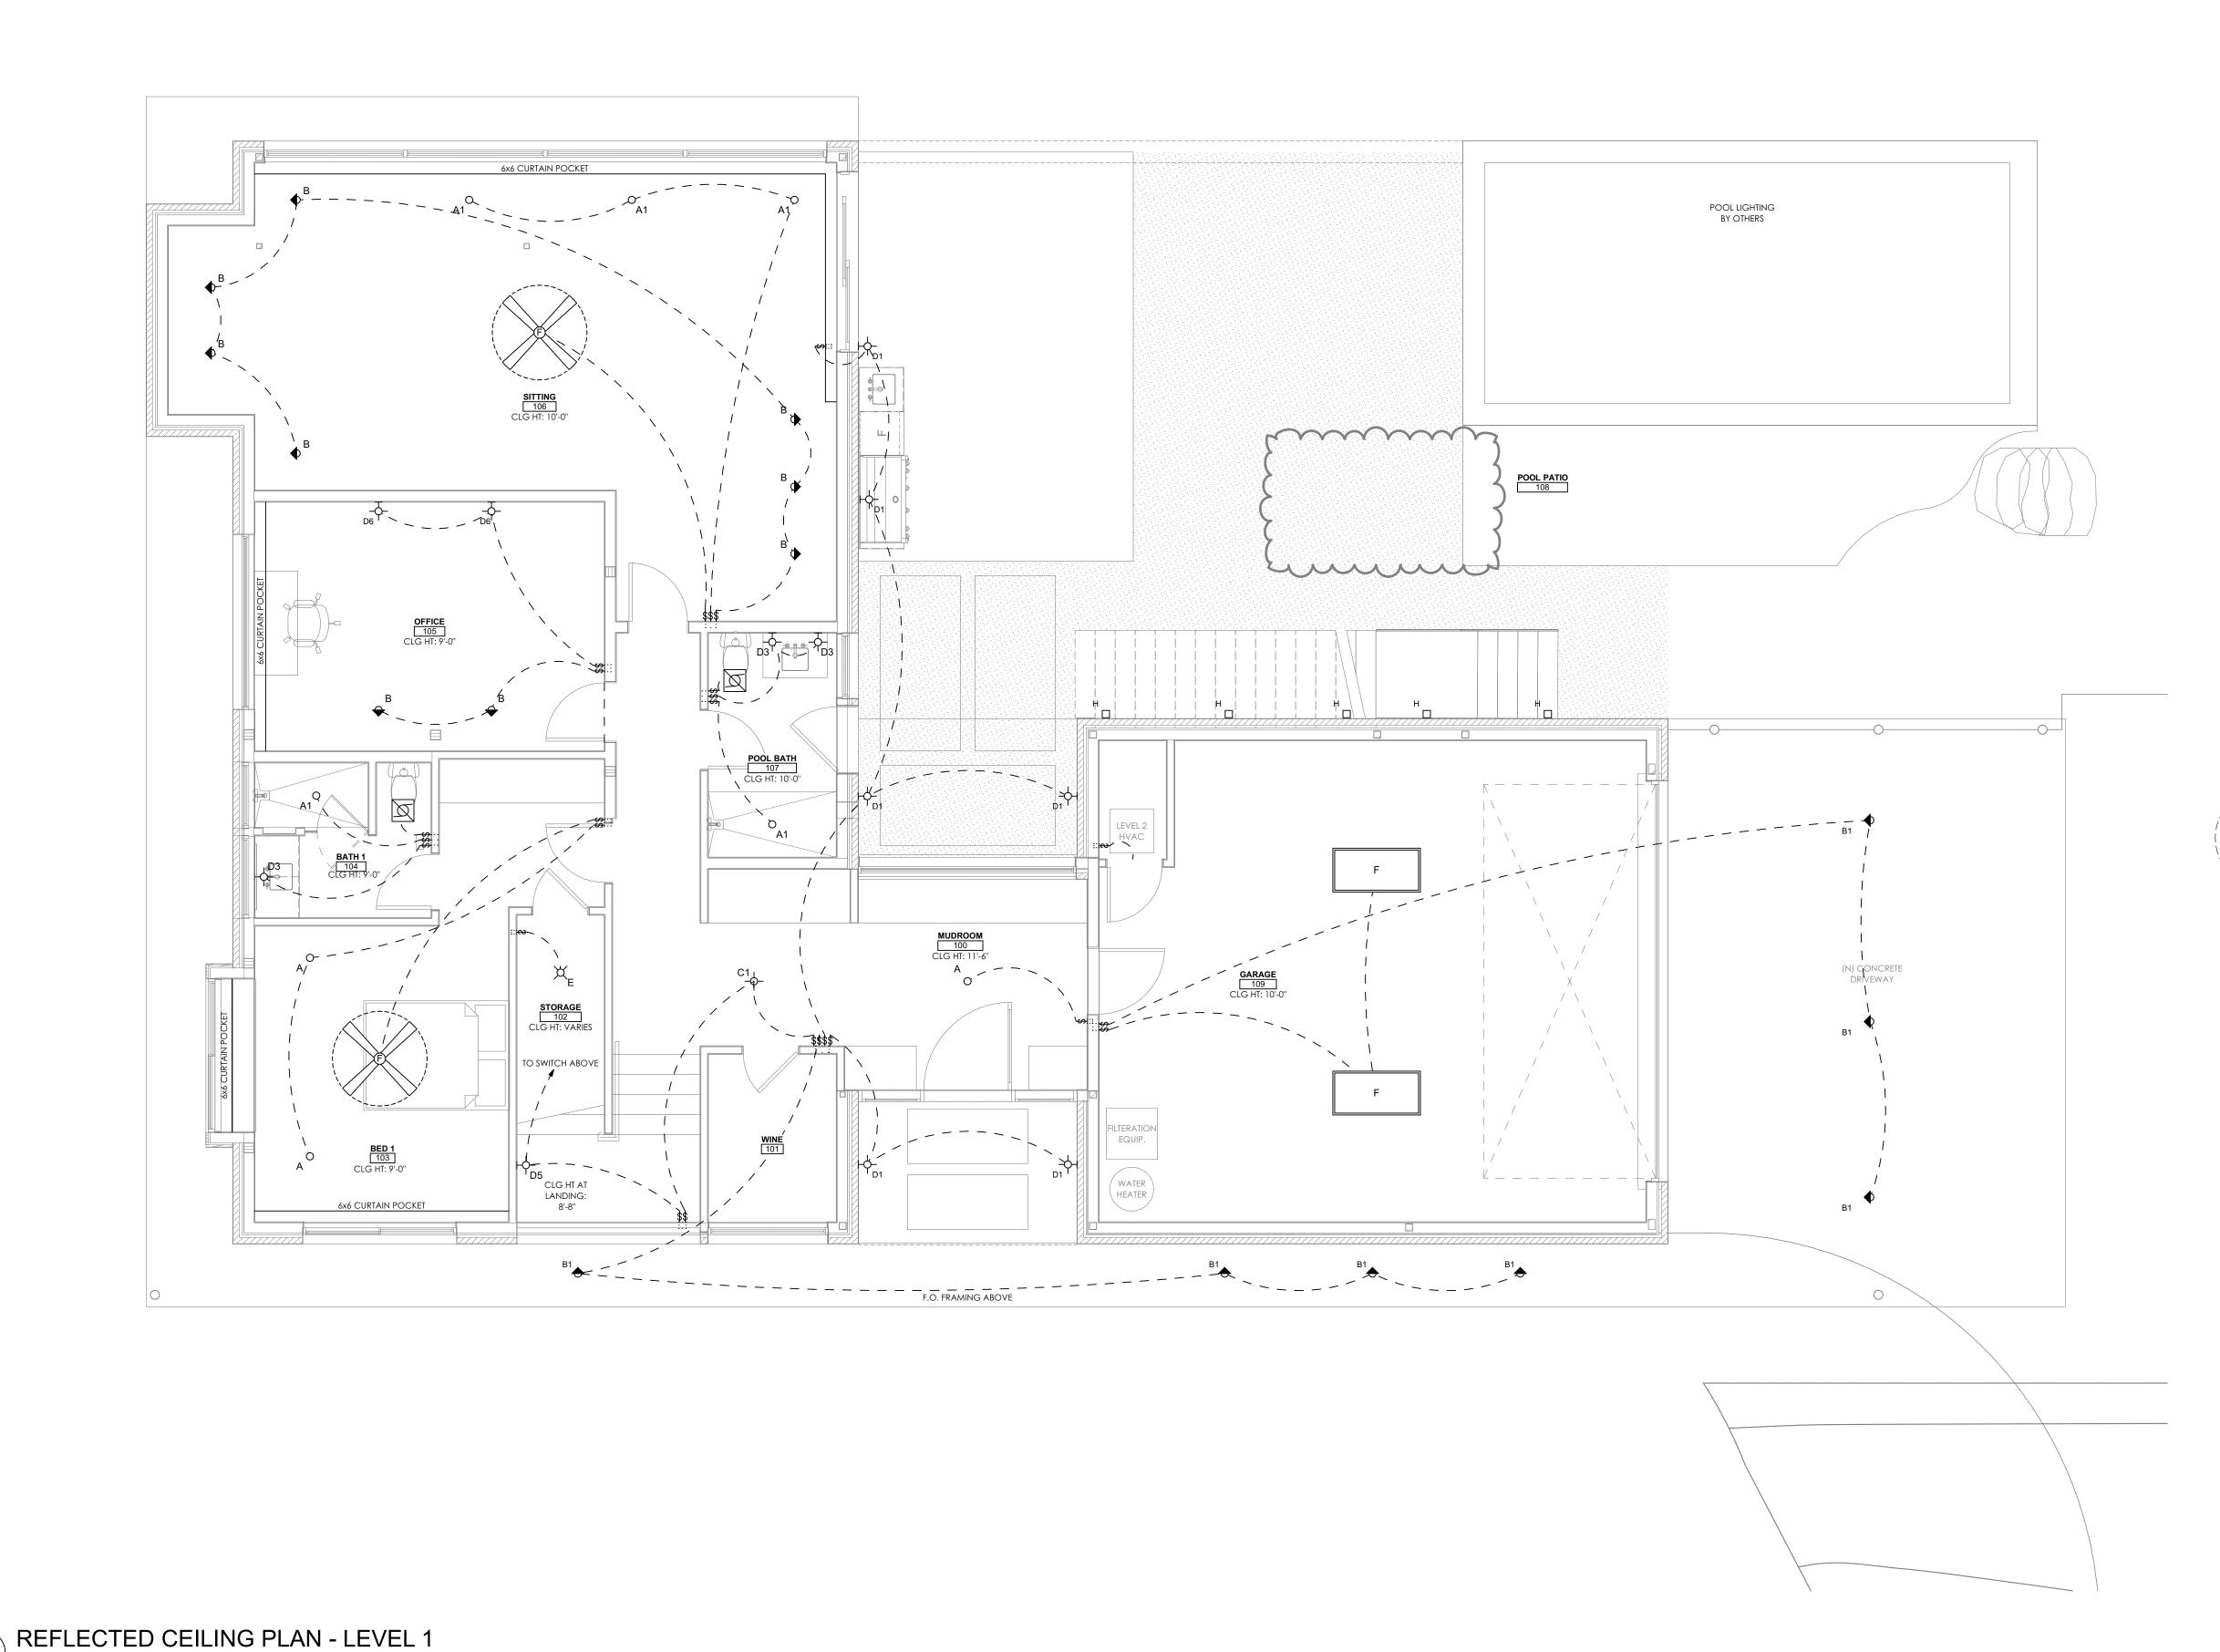

N SCALE: 1/4" = 1'-0"

GENERAL NOTES:

1. ALL OUTLETS TO BE PLACED ACCORDING TO CODE.

2. ALL SMOKE AND C.O. DETECTORS PLACED ACCORDING TO CODE

3. CENTERLINE WHERE NOTED

4. ALIGN CANS WHERE NOTED, IF THERE IS A CONFLICT NOTIFY ARCHITECT

5. PRE WIRE FOR A/V SOUND SYSTEM

6. COORDINATE WITH ARCHITECT & AV CONSULTANT FOR WIRING LOCATIONS

7. ALL EXTERIOR LIGHTING TO CONFORM WITH DARK SKY ORDINANCE

KEY:

- RECESSED CAN LIGHT FIXTURE
- → DIRECTIONAL (WALL-WASHER) FIXT
- STEP LIGHT

LINEAR FIXT.

CHANDELIER

□ SURFACE MOUNTED

 \div WALL MOUNTED (SCONCE) FIXT

CLG MOUNTED FIXT

SECURITY LIGHT FIXTURE

LANDSCAPE UPLIGHT

SMOKE DETECTOR

CARRON MONOYID

CARBON MONOXIDE DETECTOR

THERMOSTAT

© SPEAKER



S/A DIFFUSER

☐ R/A GRILLE


WALL MOUNTED S/A
DIFFUSER

WALL MOUNTED R/A
GRILL



PELLNER

804 CANYON CREEK
WEST LAKE HILLS TX 787.

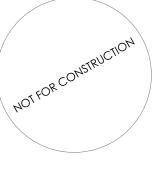

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FOR CONSTRUCTION

DRAWING TITLE: RCP


SCALE: AS NOTED

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DATE: 6/19/2025

SHEET NUMBER:

A2.20



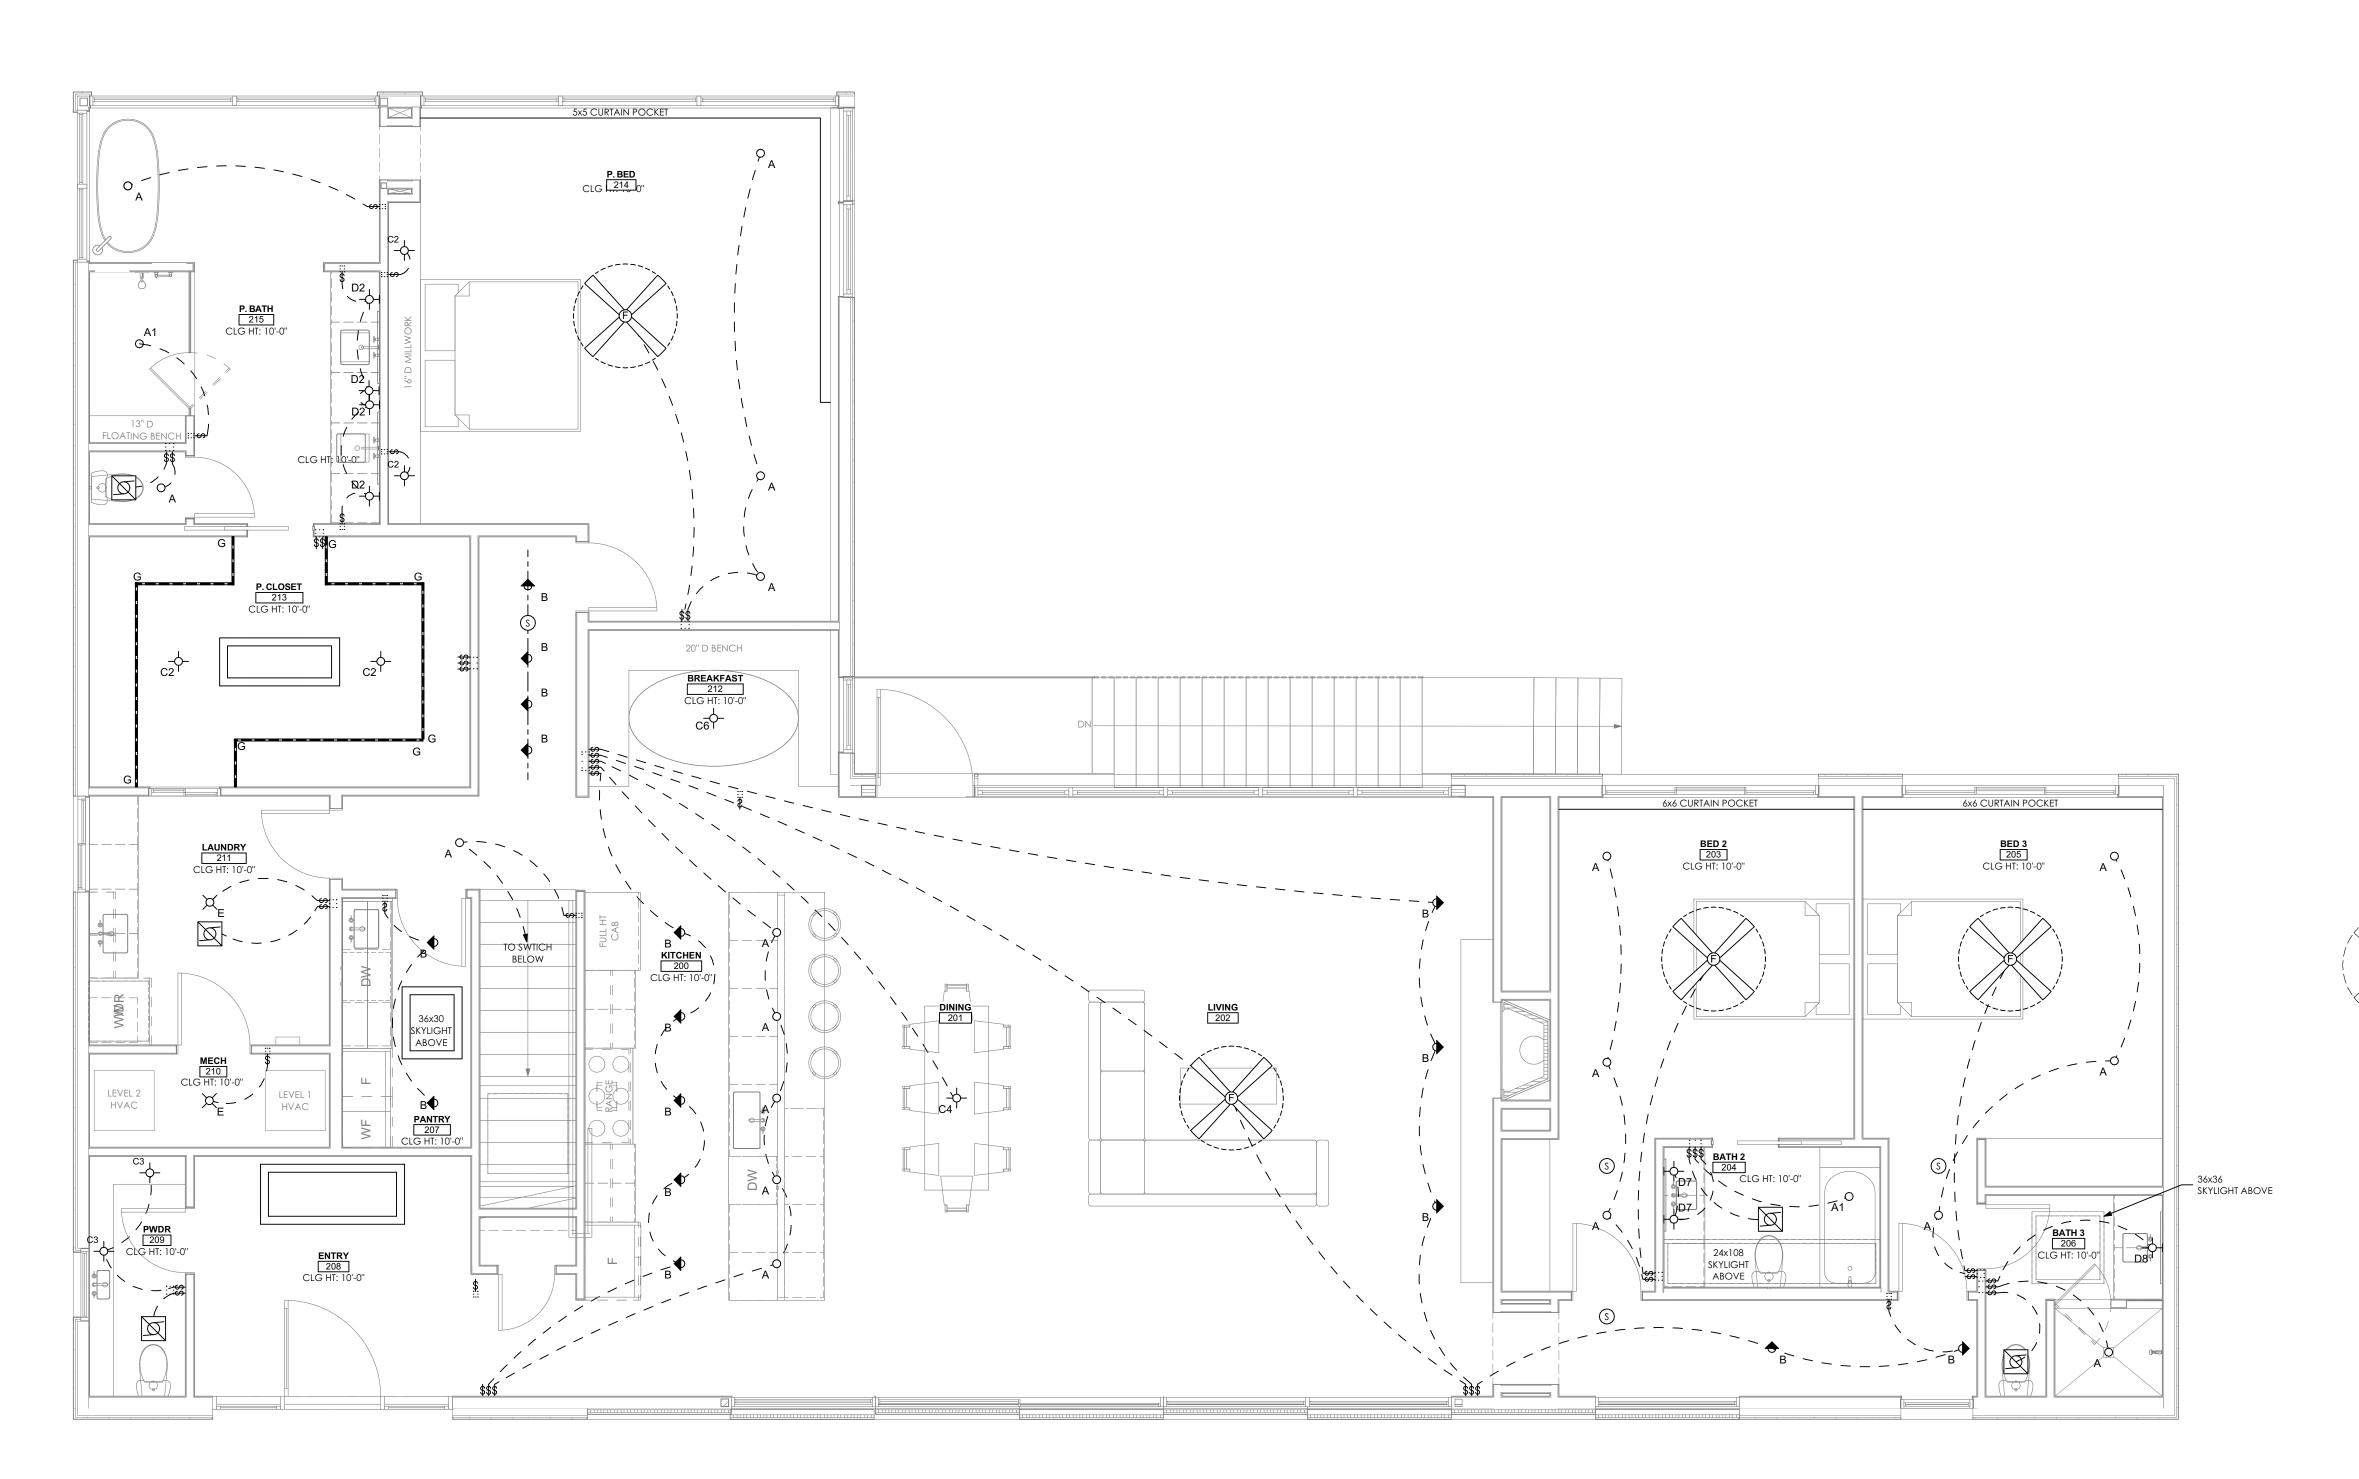

GENERAL NOTES:

1. ALL OUTLETS TO BE PLACED ACCORDING TO CODE.

2. ALL SMOKE AND C.O. DETECTORS PLACED ACCORDING TO CODE

3. CENTERLINE WHERE NOTED

4. ALIGN CANS WHERE NOTED, IF THERE IS A CONFLICT NOTIFY ARCHITECT

5. PRE WIRE FOR A/V SOUND SYSTEM

6. COORDINATE WITH ARCHITECT & AV CONSULTANT FOR WIRING LOCATIONS

7. ALL EXTERIOR LIGHTING TO CONFORM WITH DARK SKY ORDINANCE

KE,

- RECESSED CAN LIGHT FIXTURE
- → DIRECTIONAL (WALL-WASHER) FIXT
- STEP LIGHT

LINEAR FIXT.

CHANDELIER

- PENDANT

□ SURFACE MOUNTED

CLG MOUNTED FIXT

SECURITY LIGHT FIXTURE

LANDSCAPE UPLIGHT

S SMOKE DETECTOR

CARBON MONOXIDE DETECTOR

THERMOSTAT

11 ILKMO317

© SPEAKER

CEILING FAN W.O LIGHT KIT

S/A DIFFUSER

□ R/A GRILLE

WALL MOUNTED S/A
DIFFUSER

WALL MOUNTED R/A

GRILL



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FOR CONSTRUCTION

DRAWING TITLE: RCP


SCALE: AS NOTED

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DATE: 6/19/2025

SHEET NUMBER:

A2.2

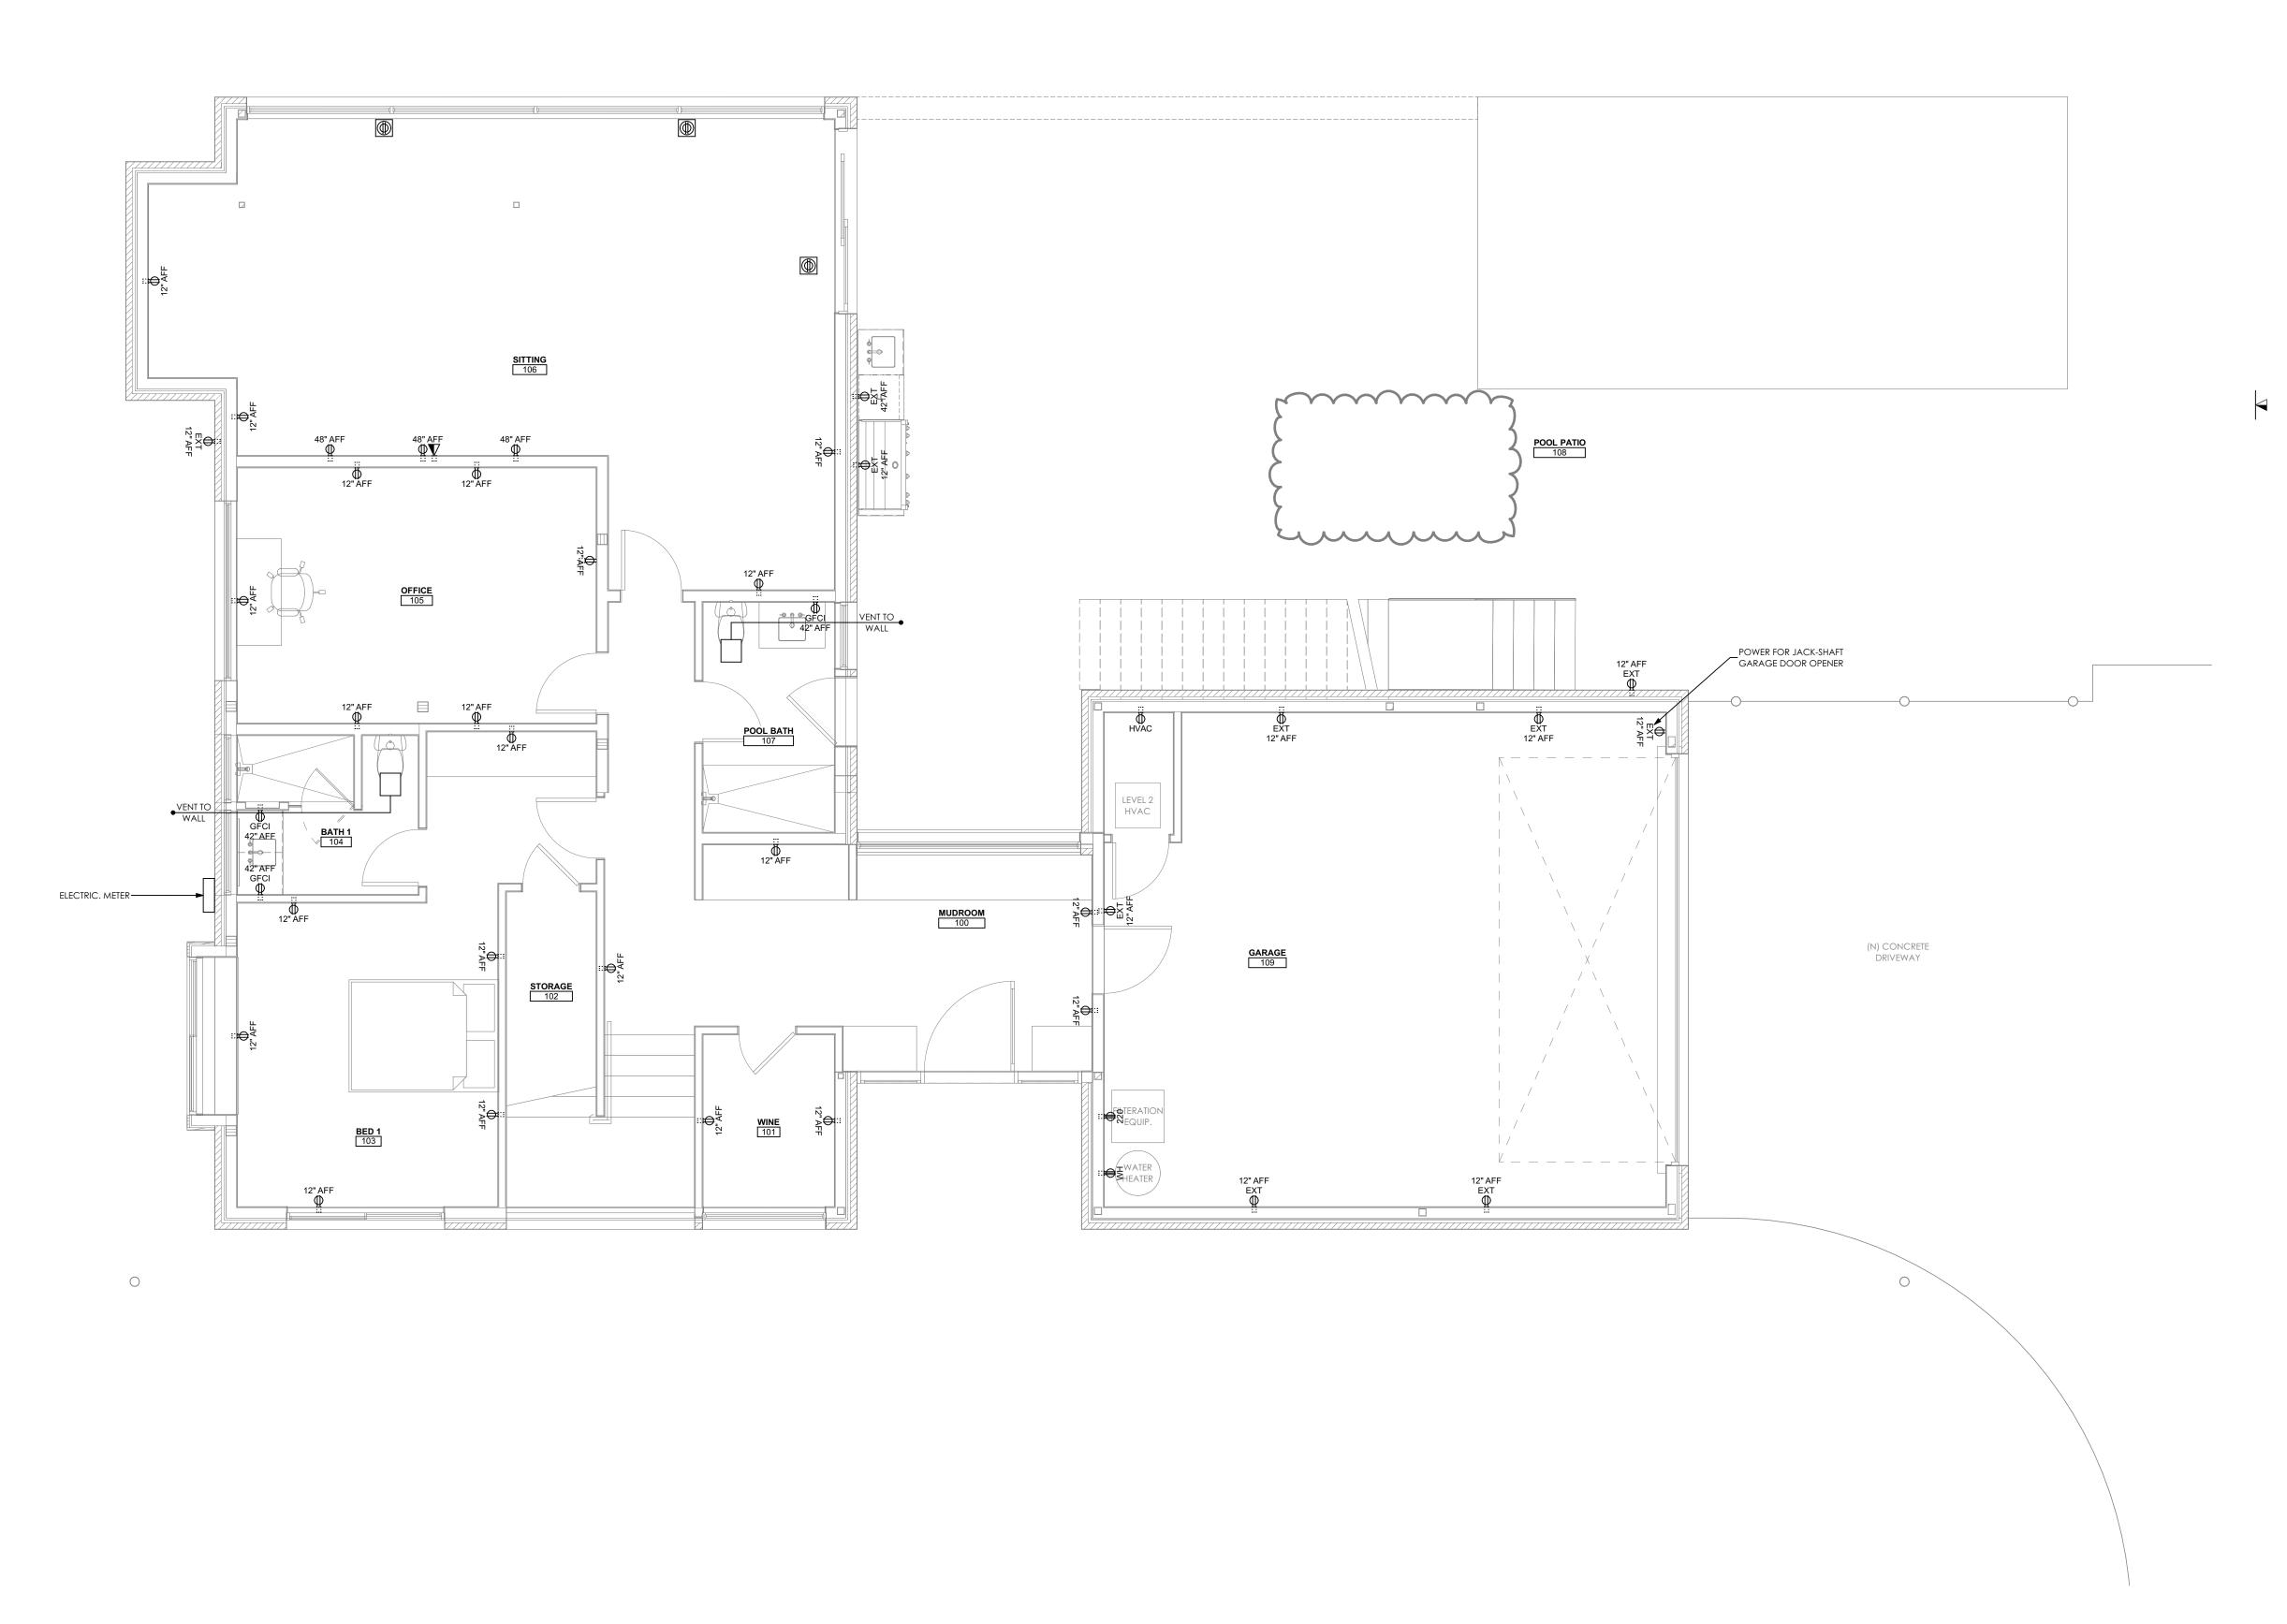

POWER + MECHANICAL PLAN - LEVEL 1 N SCALE: 1/4" = 1'-0"

GENERAL NOTES:

1. ALL OUTLETS TO BE PLACED ACCORDING TO CODE.

2. ALL SMOKE AND C.O. DETECTORS PLACED ACCORDING TO CODE

3. CENTERLINE WHERE NOTED

4. ALIGN CANS WHERE NOTED, IF THERE IS A CONFLICT NOTIFY ARCHITECT

5. PRE WIRE FOR A/V SOUND SYSTEM

6. COORDINATE WITH ARCHITECT & AV CONSULTANT FOR WIRING LOCATIONS

KEY:

18" AFF DUPLEX OUTLET

SWITCHED DUPLEX OUTLET

MULTI OUTLET

220V OUTLET


DATA ONLY - SINGLE / DUPLEX / MULTI-PORT

FLUSH FLOOR MTD. "J" BOX W/ DUPLEX OR 4 PLEX OUTLET

CABLE PASS THROUGH PAIR IN-WALL WITH DUCT MOUNTED 42" AFF & 15"AFF



DO NOT SCALE DRAWING

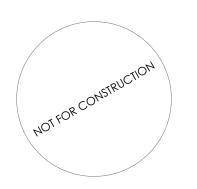

SEAL

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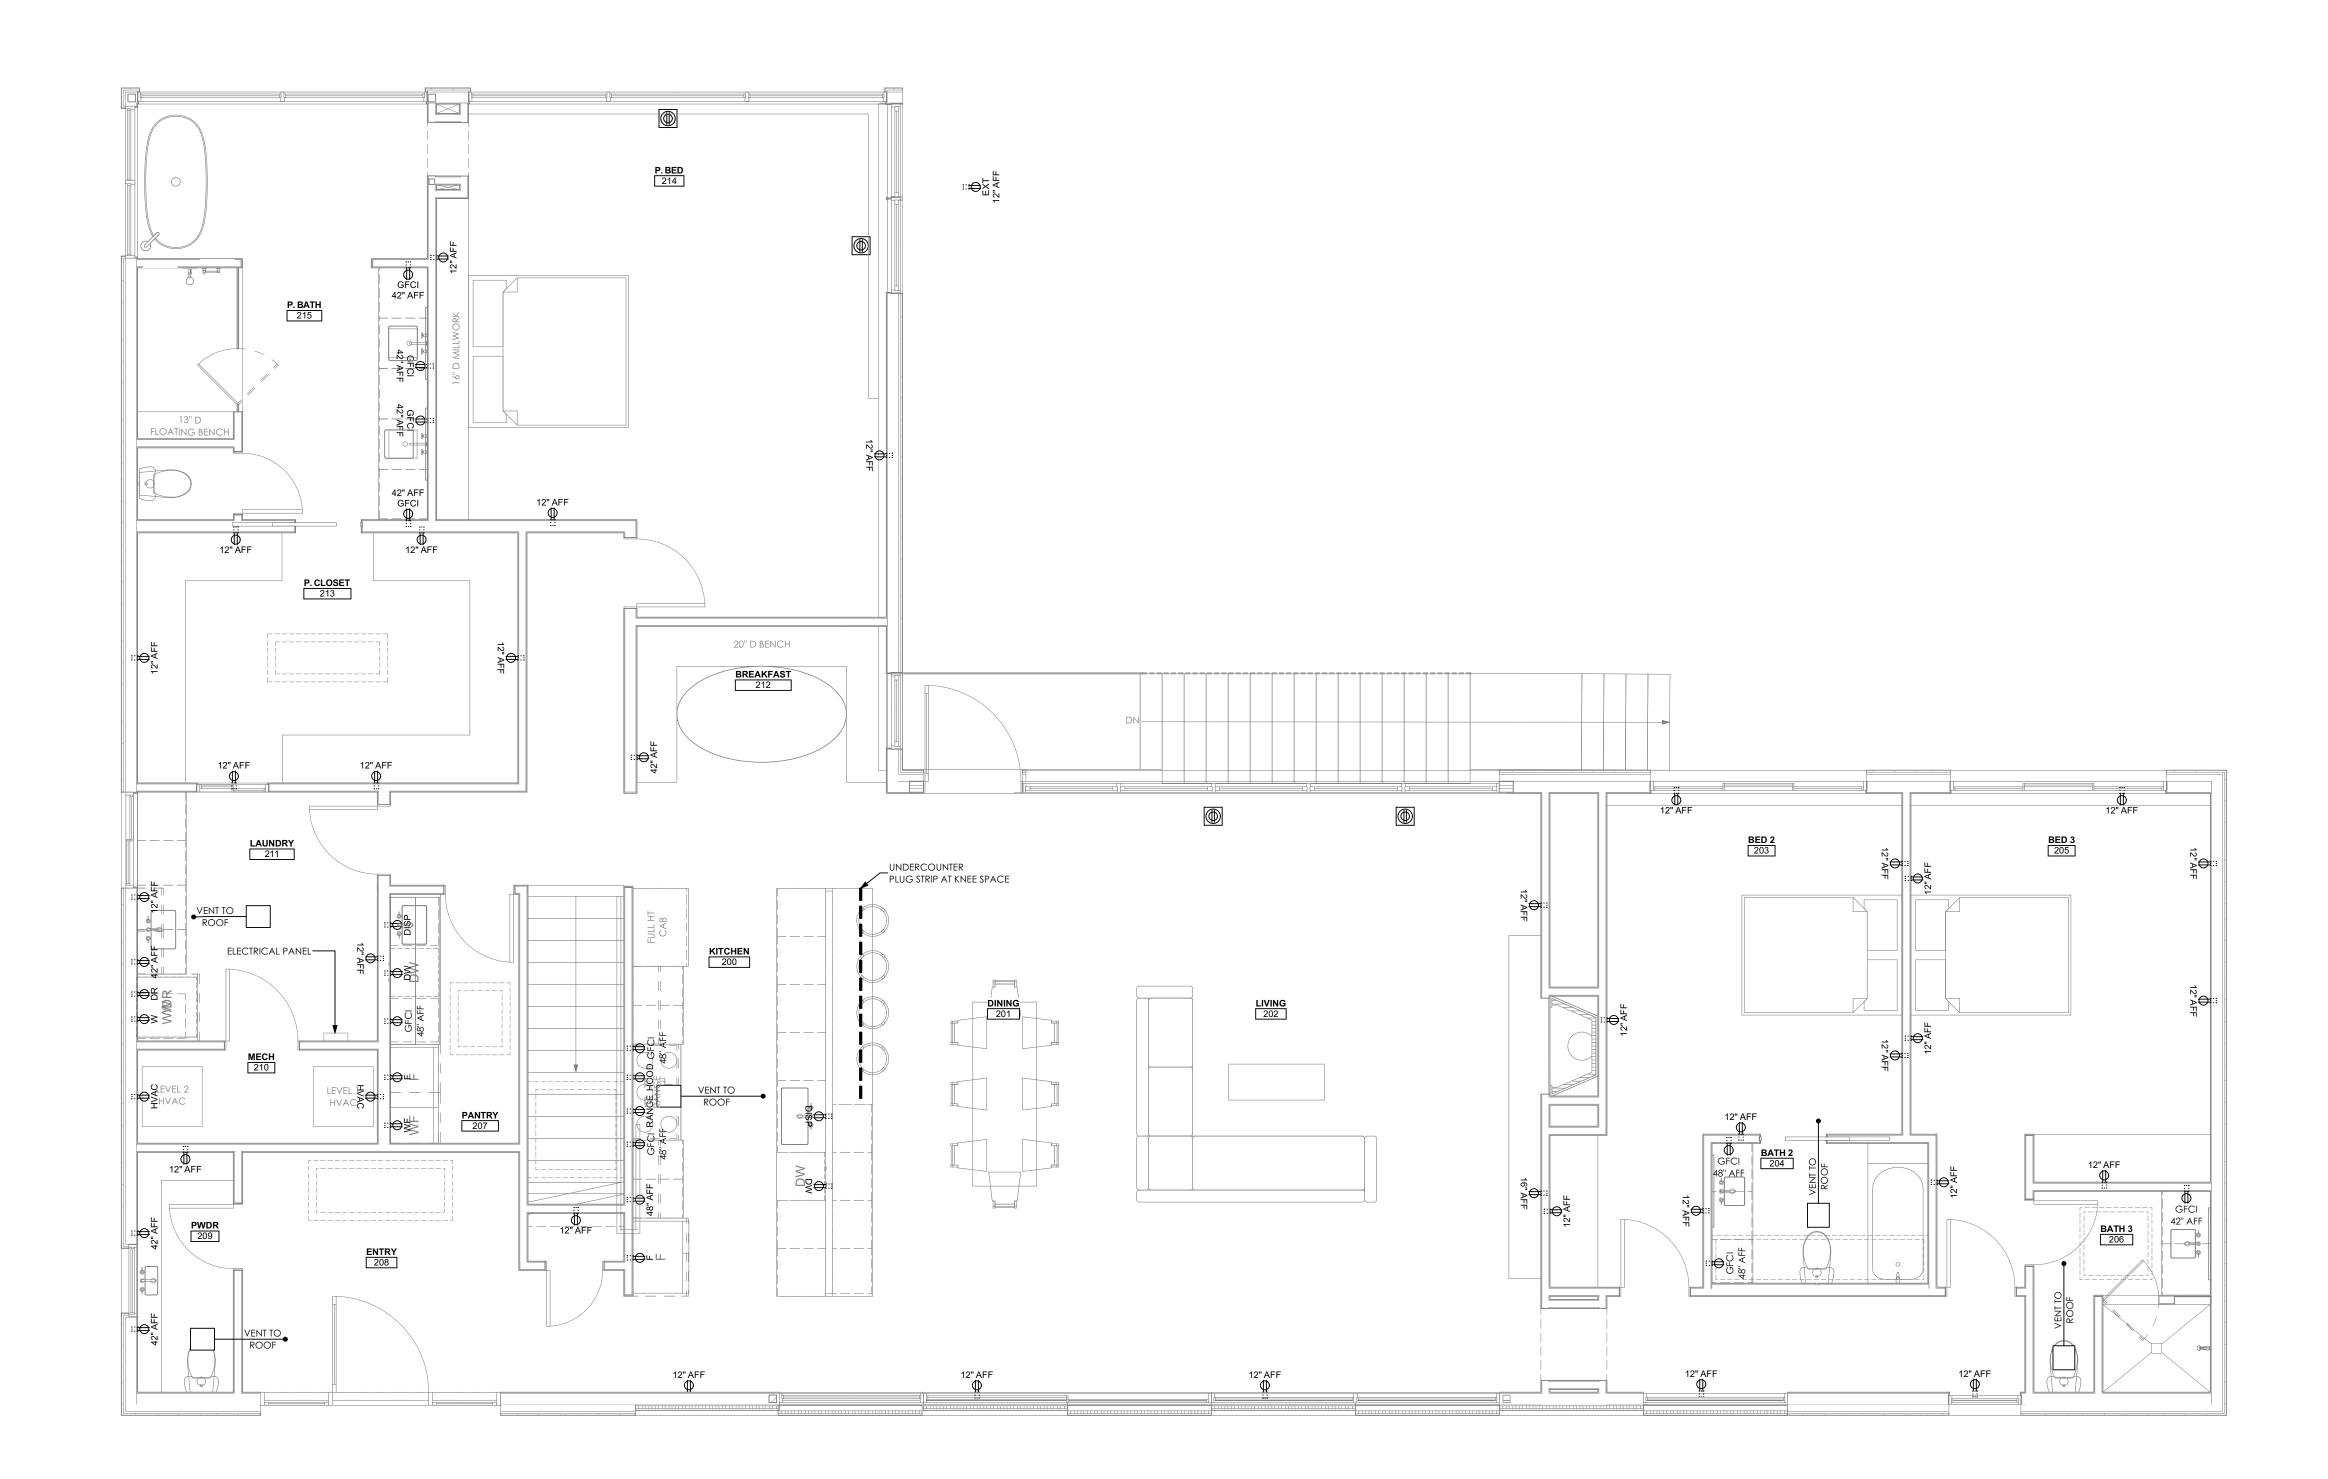
FOR CONSTRUCTION

DRAWING TITLE: POWER + MECHANICAL PLAN SCALE: AS NOTED

SCALES ARE 50% OF NOTED WHEN PRINTED ON 11 X 17 PAPER

DATE: 6/19/2025

SHEET NUMBER:



POWER + MECHANICAL PLAN - LEVEL 2

SCALE: 1/4" = 1'-0"

GENERAL NOTES:

1. ALL OUTLETS TO BE PLACED ACCORDING TO CODE.

2. ALL SMOKE AND C.O. DETECTORS PLACED ACCORDING TO CODE

3. CENTERLINE WHERE NOTED

4. ALIGN CANS WHERE NOTED, IF THERE IS A CONFLICT NOTIFY ARCHITECT

5. PRE WIRE FOR A/V SOUND SYSTEM

6. COORDINATE WITH ARCHITECT & AV CONSULTANT FOR WIRING LOCATIONS

KEY:

18" AFF DUPLEX OUTLET

SWITCHED DUPLEX OUTLET

MULTI OUTLET

⊕ 220V OUTLET

MULTI-PORT

FLUSH FLOOR MTD. "J" BOX W/ DUPLEX OR 4 PLEX OUTLET

DATA ONLY - SINGLE / DUPLEX /

CABLE PASS THROUGH PAIR IN-WALL WITH DUCT MOUNTED 42" AFF & 15"AFF



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WEST LAKE HILLS TX 78746



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restrictions.

DRAWING TITLE:
POWER + MECHANICAL
PLAN
SCALE: AS NOTED

SCALES ARE 50% OF NOTED WHEN PRINTED ON 11 X 17 PAPER

DATE: 6/19/2025

SHEET NUMBER:

A2.3



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FOR CONSTRUCTION

DRAWING TITLE: FINISH PLANS

SCALE: AS NOTED

SCALES ARE 50% OF NOTED WHEN PRINTED ON 11 X 17 PAPER

DATE: 6/19/2025

SHEET NUMBER:

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POOL BATH
107 Ō PL-4.2 PL-4.3 PL-4.4 PL-4.2 PL-4.3 PL-4.4 LEVEL 2 HVAC PL-4 PL-4.1 STN-2 m (N) CONCRETE DRIVEWAY / \ FILTERATION EQUIP. STN-9 WATER HEATER WD-2


STN-9

• STN-9





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FOR CONSTRUCTION

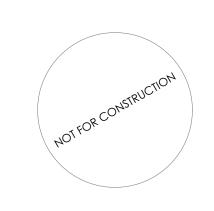DRAWING TITLE: FINISH PLANS

SCALE: AS NOTED

SCALES ARE 50% OF NOTED WHEN PRINTED ON 11 X 17 PAPER

DATE: 6/19/2025

SHEET NUMBER:



P. BATH 215

P. CLOSET

LEVEL 1 HVAC

STN-4

20" D BENCH

STN-10

PL-1-6

STN-6

PL-10.1

LEVEL 2 HVAC

13" D FLOATING BENCH





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FOR CONSTRUCTION

DRAWING TITLE: BUILDING ELEVATIONS


SCALE: AS NOTED

SCALES ARE 50% OF NOTED WHEN PRINTED ON 11 X 17 PAPER

DATE: 6/19/2025


SHEET NUMBER:

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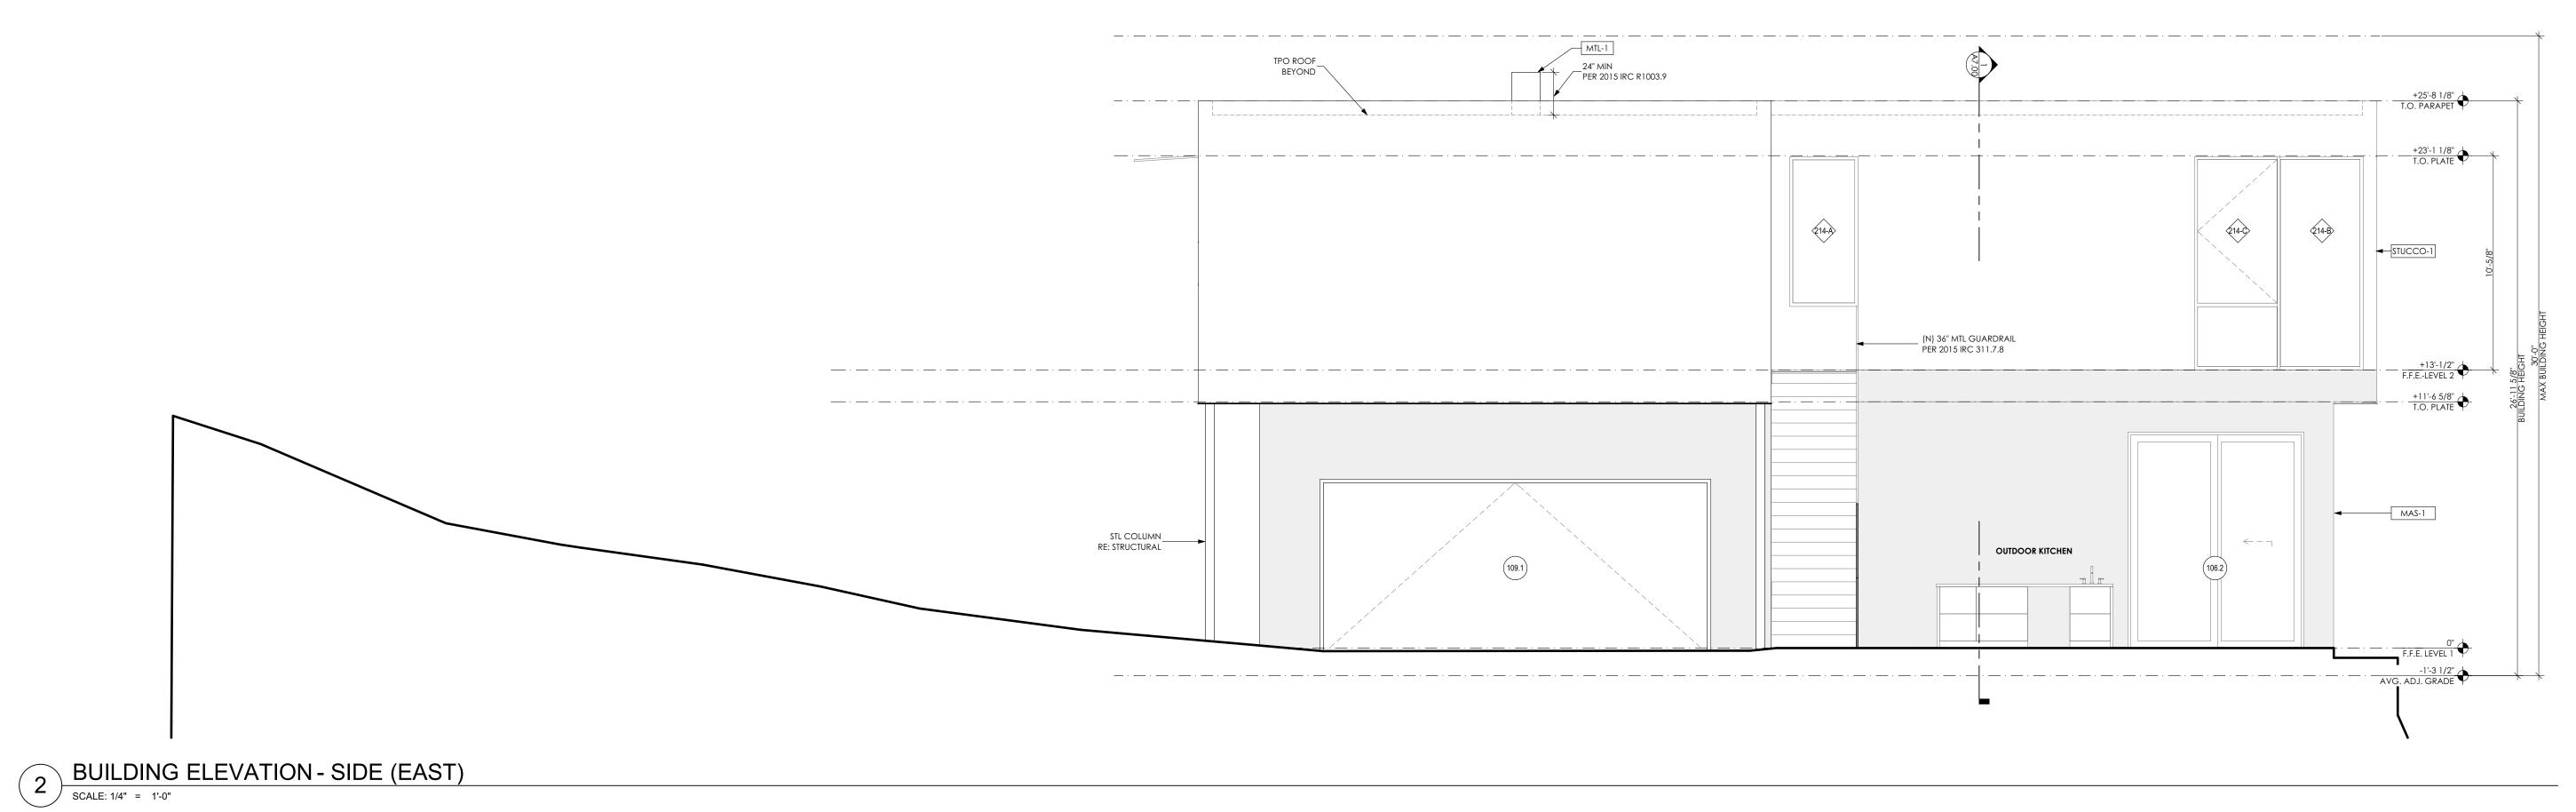
2 BUILDING ELEVATION - SIDE (WEST)

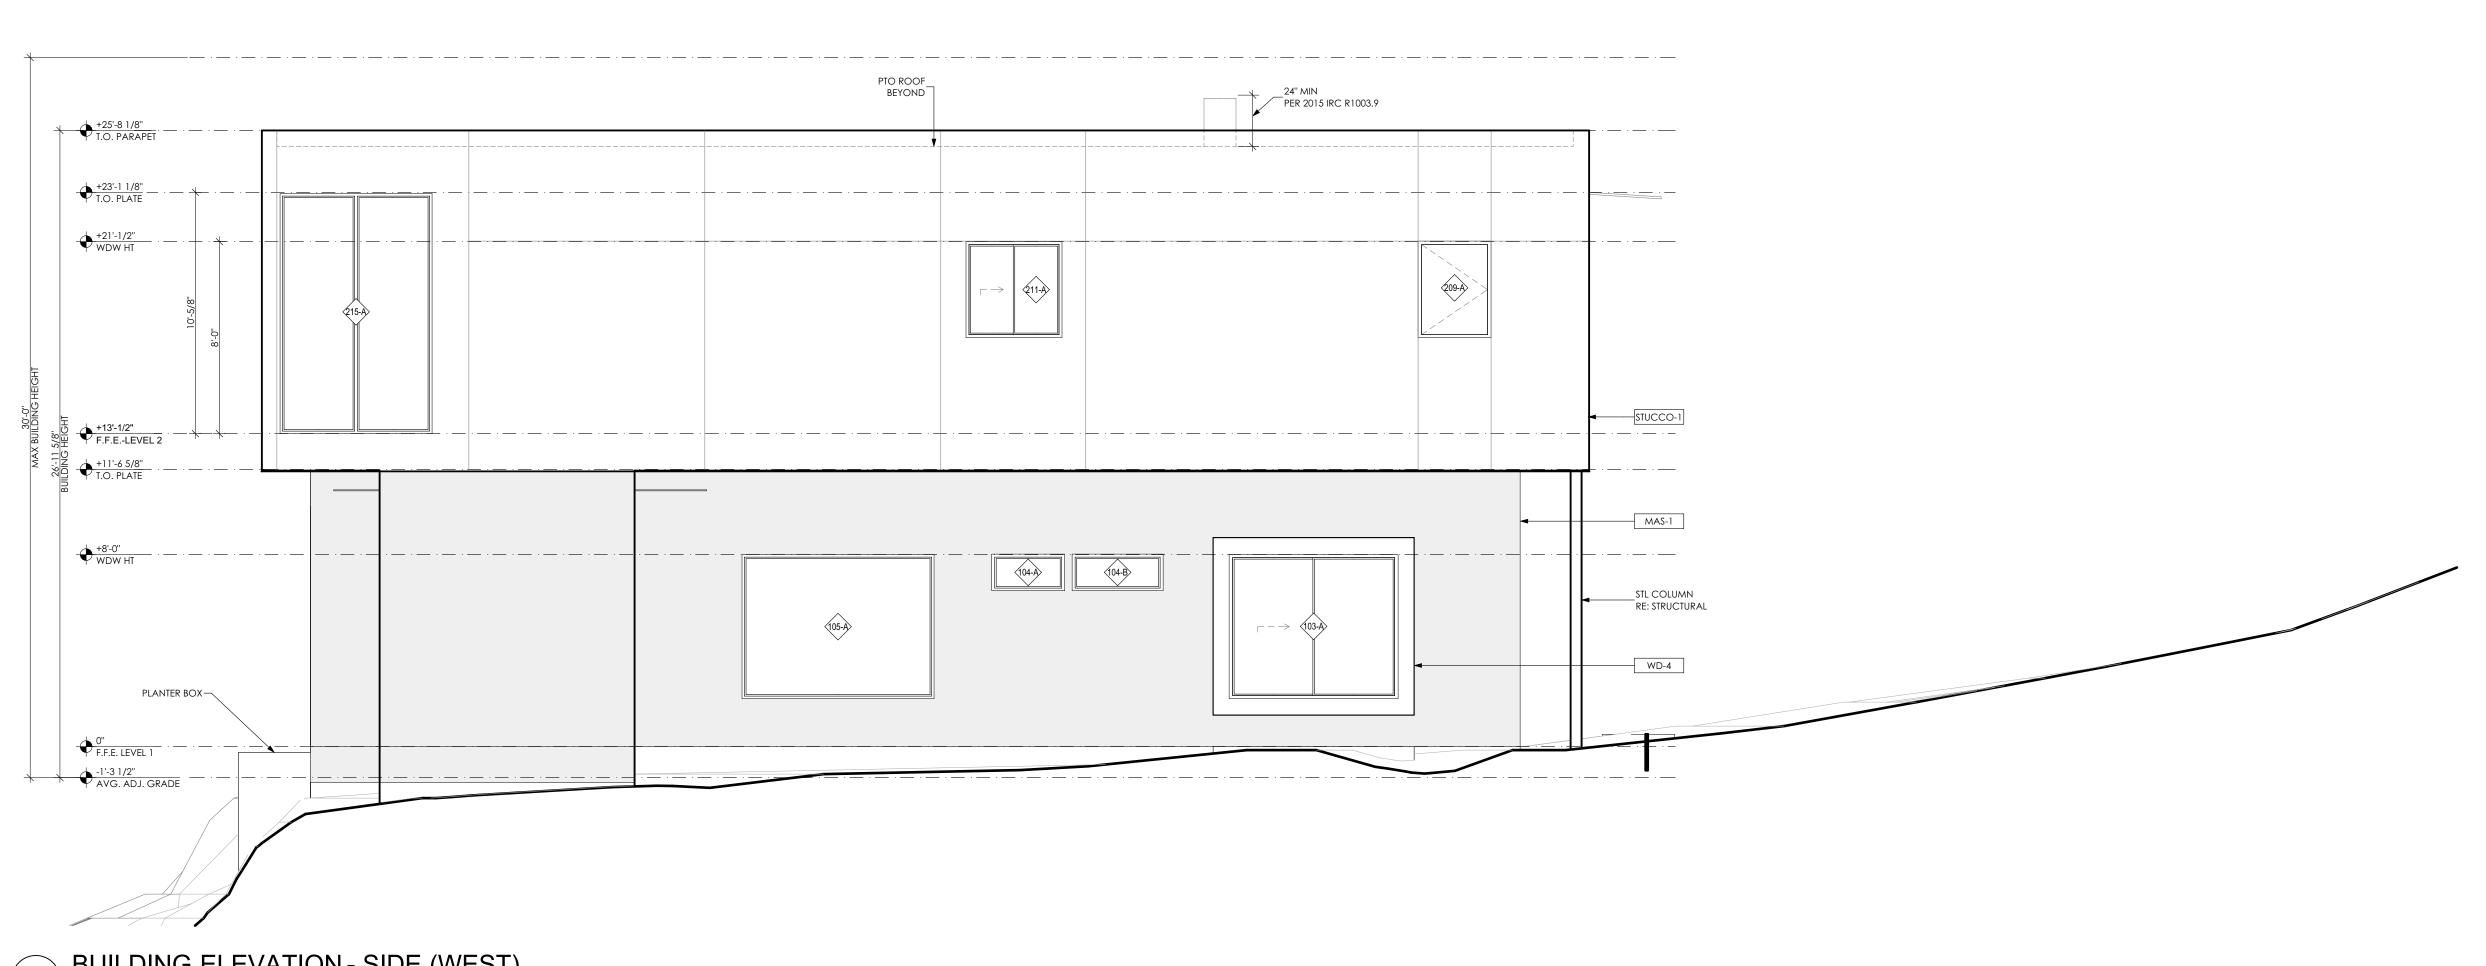SCALE: 1/4" = 1'-0"



BUILDING ELEVATION - FRONT (SOUTH)

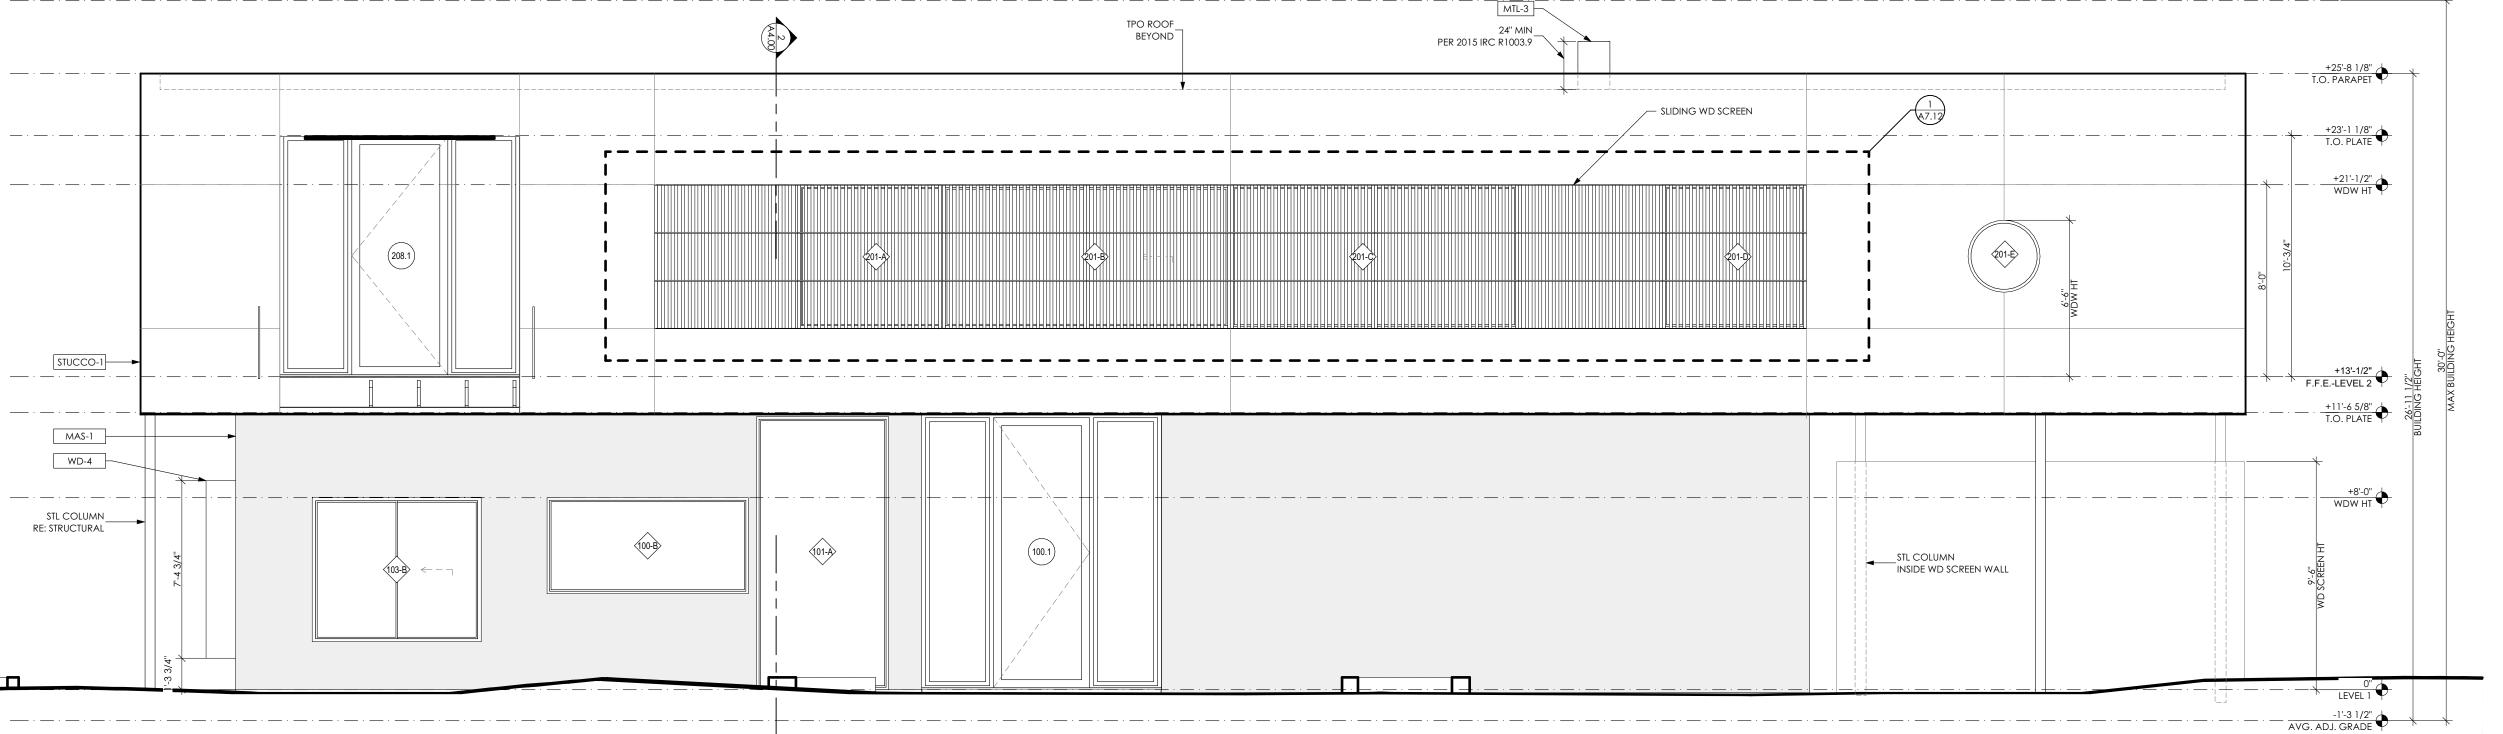SCALE: 1/4" = 1'-0"





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WEST LAKE HILLS TX 787.

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FOR CONSTRUCTION

DRAWING TITLE: BUILDING ELEVATIONS

SCALE: AS NOTED

SCALES ARE 50% OF NOTED WHEN PRINTED ON 11 X 17 PAPER

DATE: 6/19/2025


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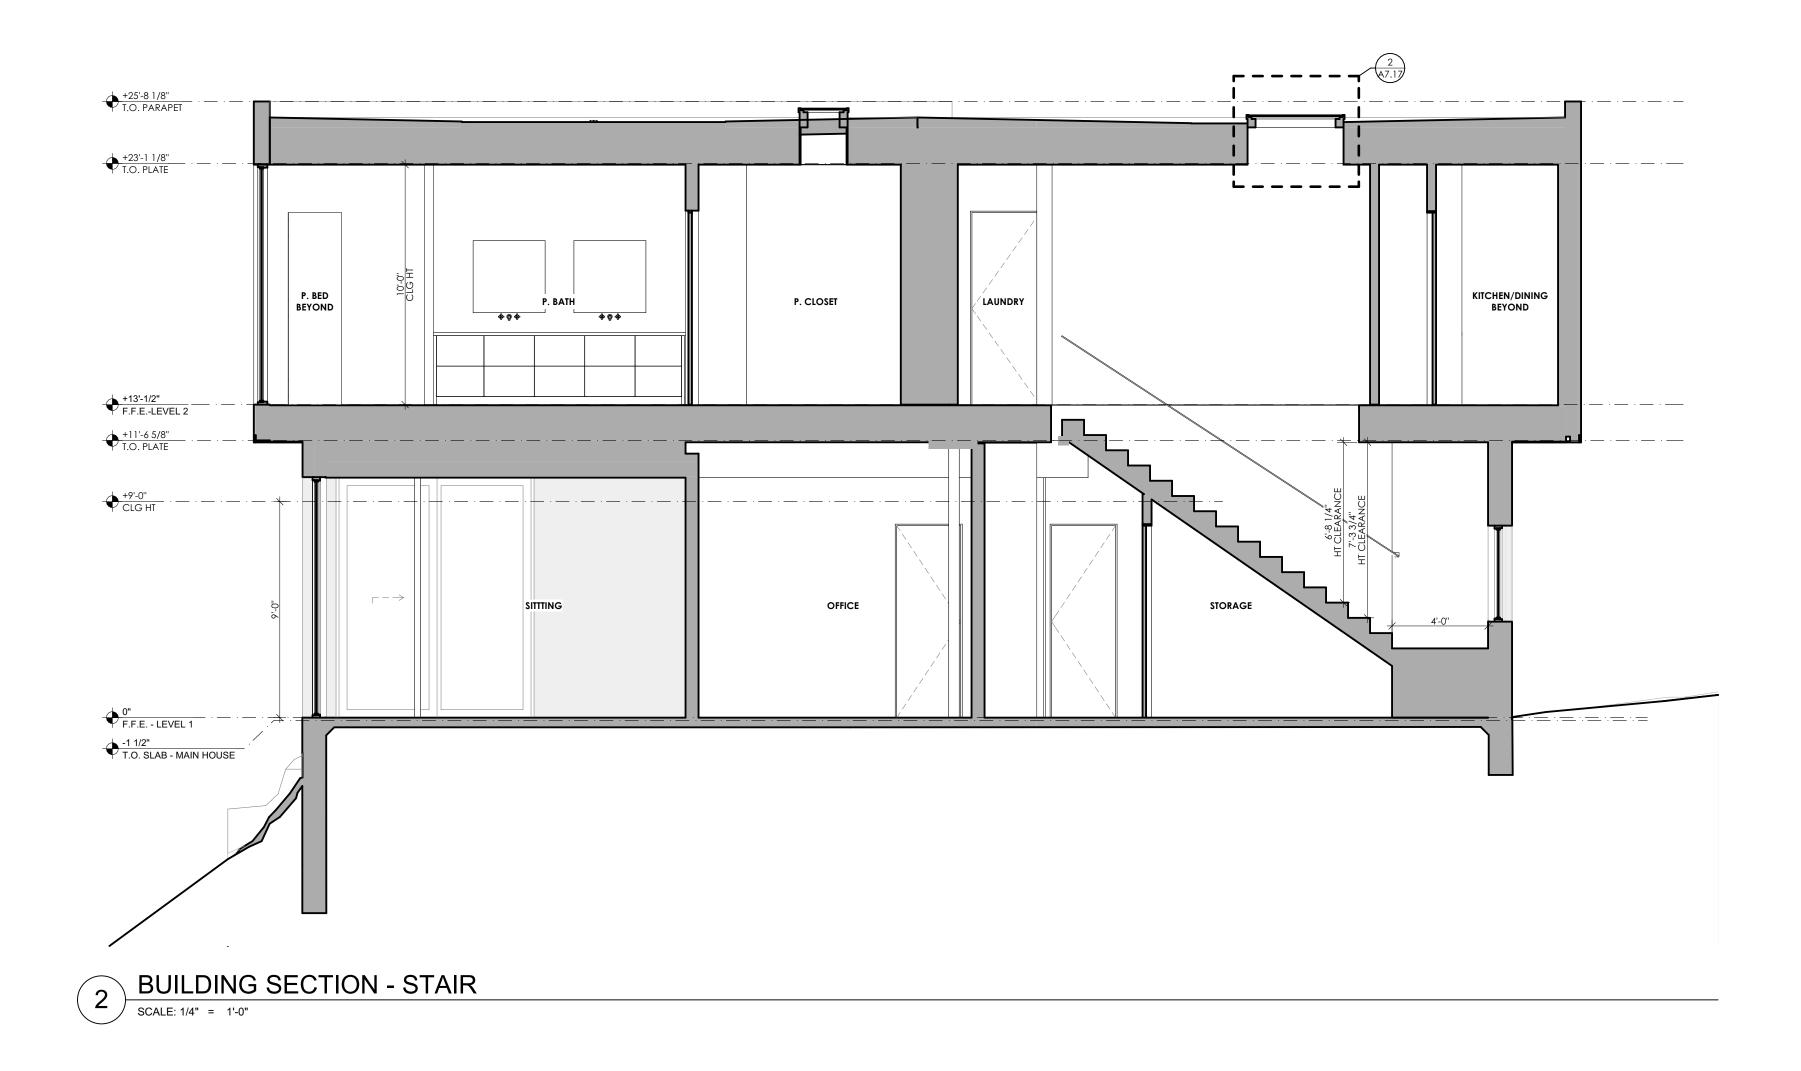
A3.0


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BUILDING ELEVATION - REAR (NORTH)

SCALE: 1/4" = 1'-0"





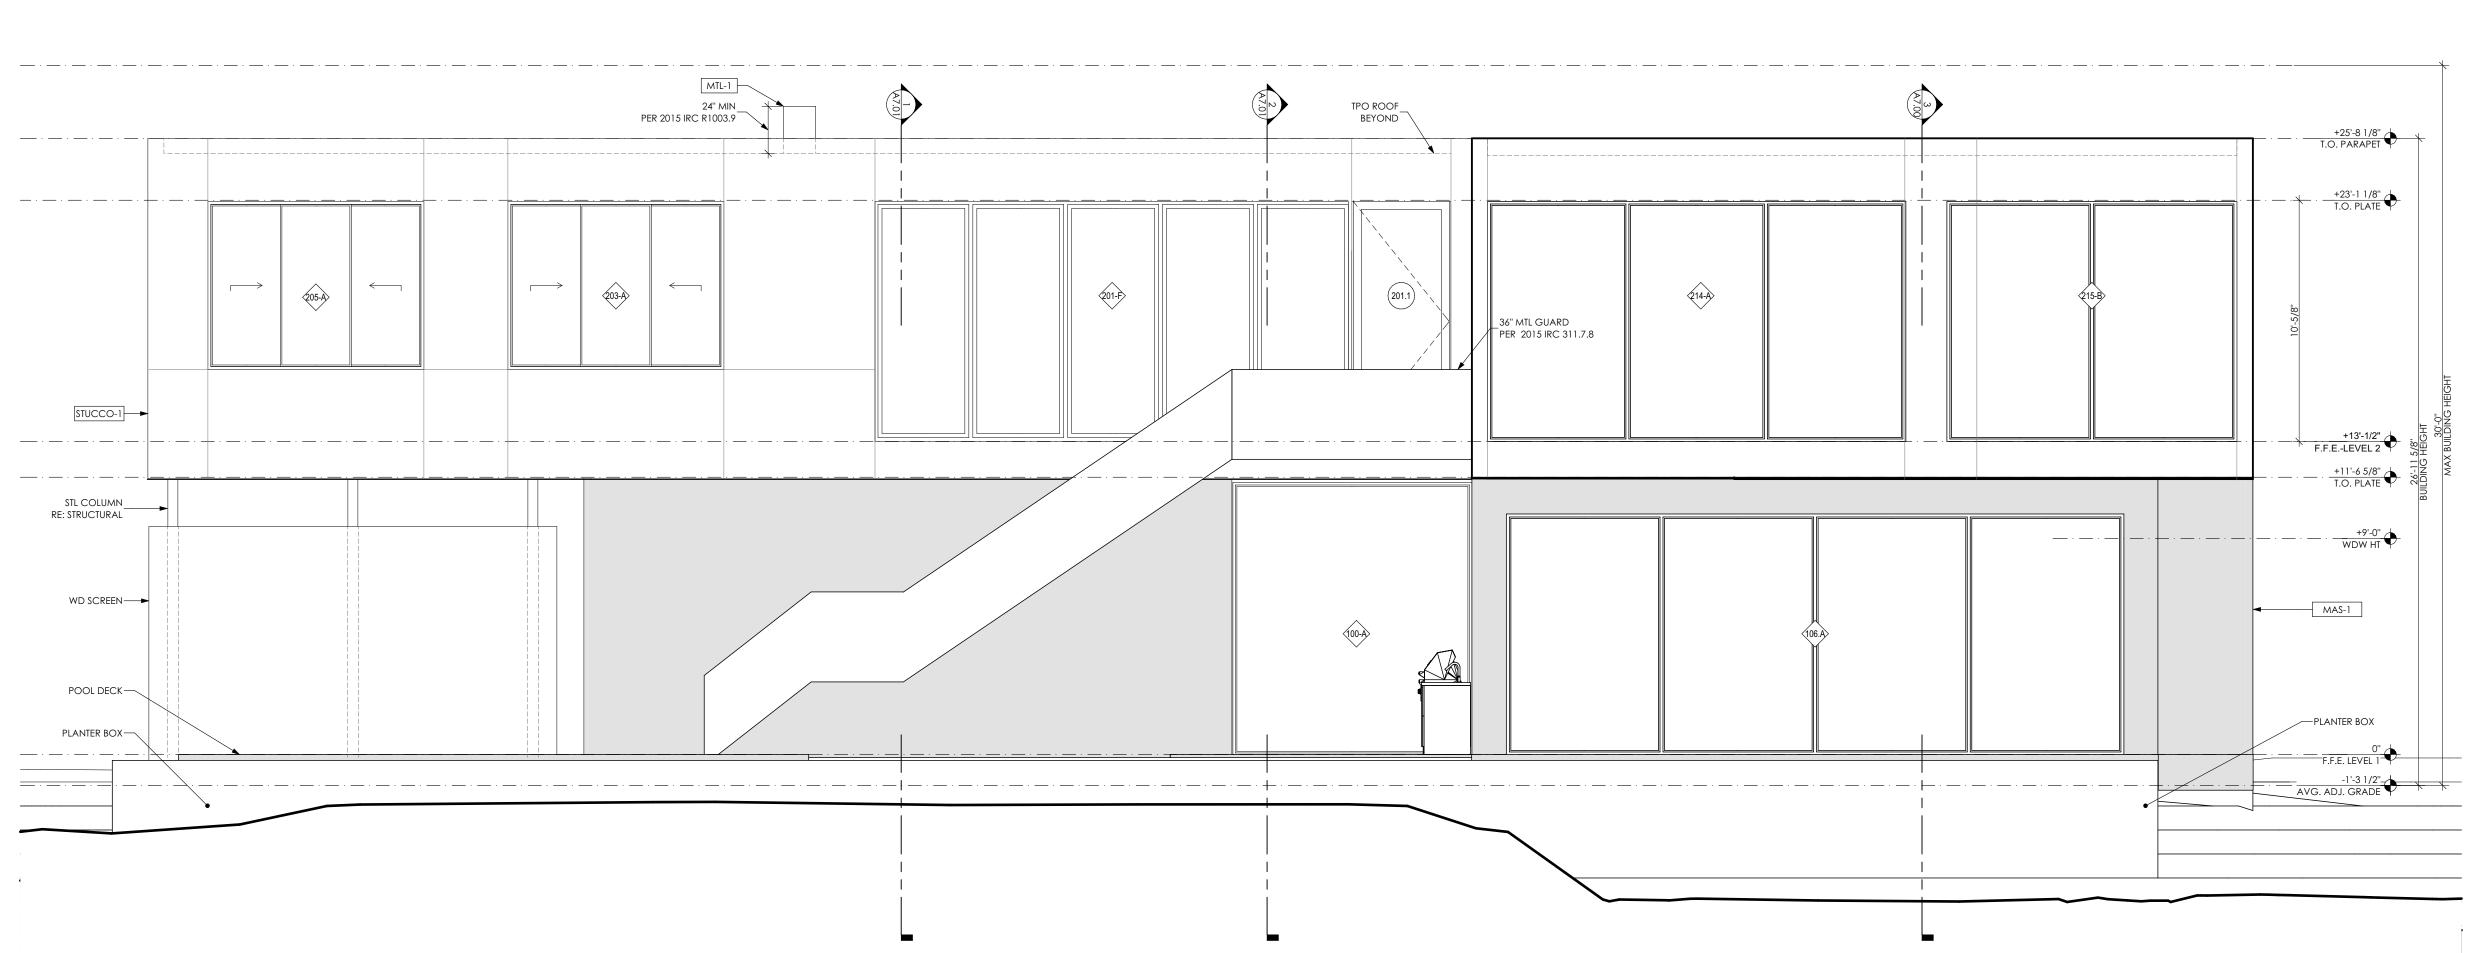

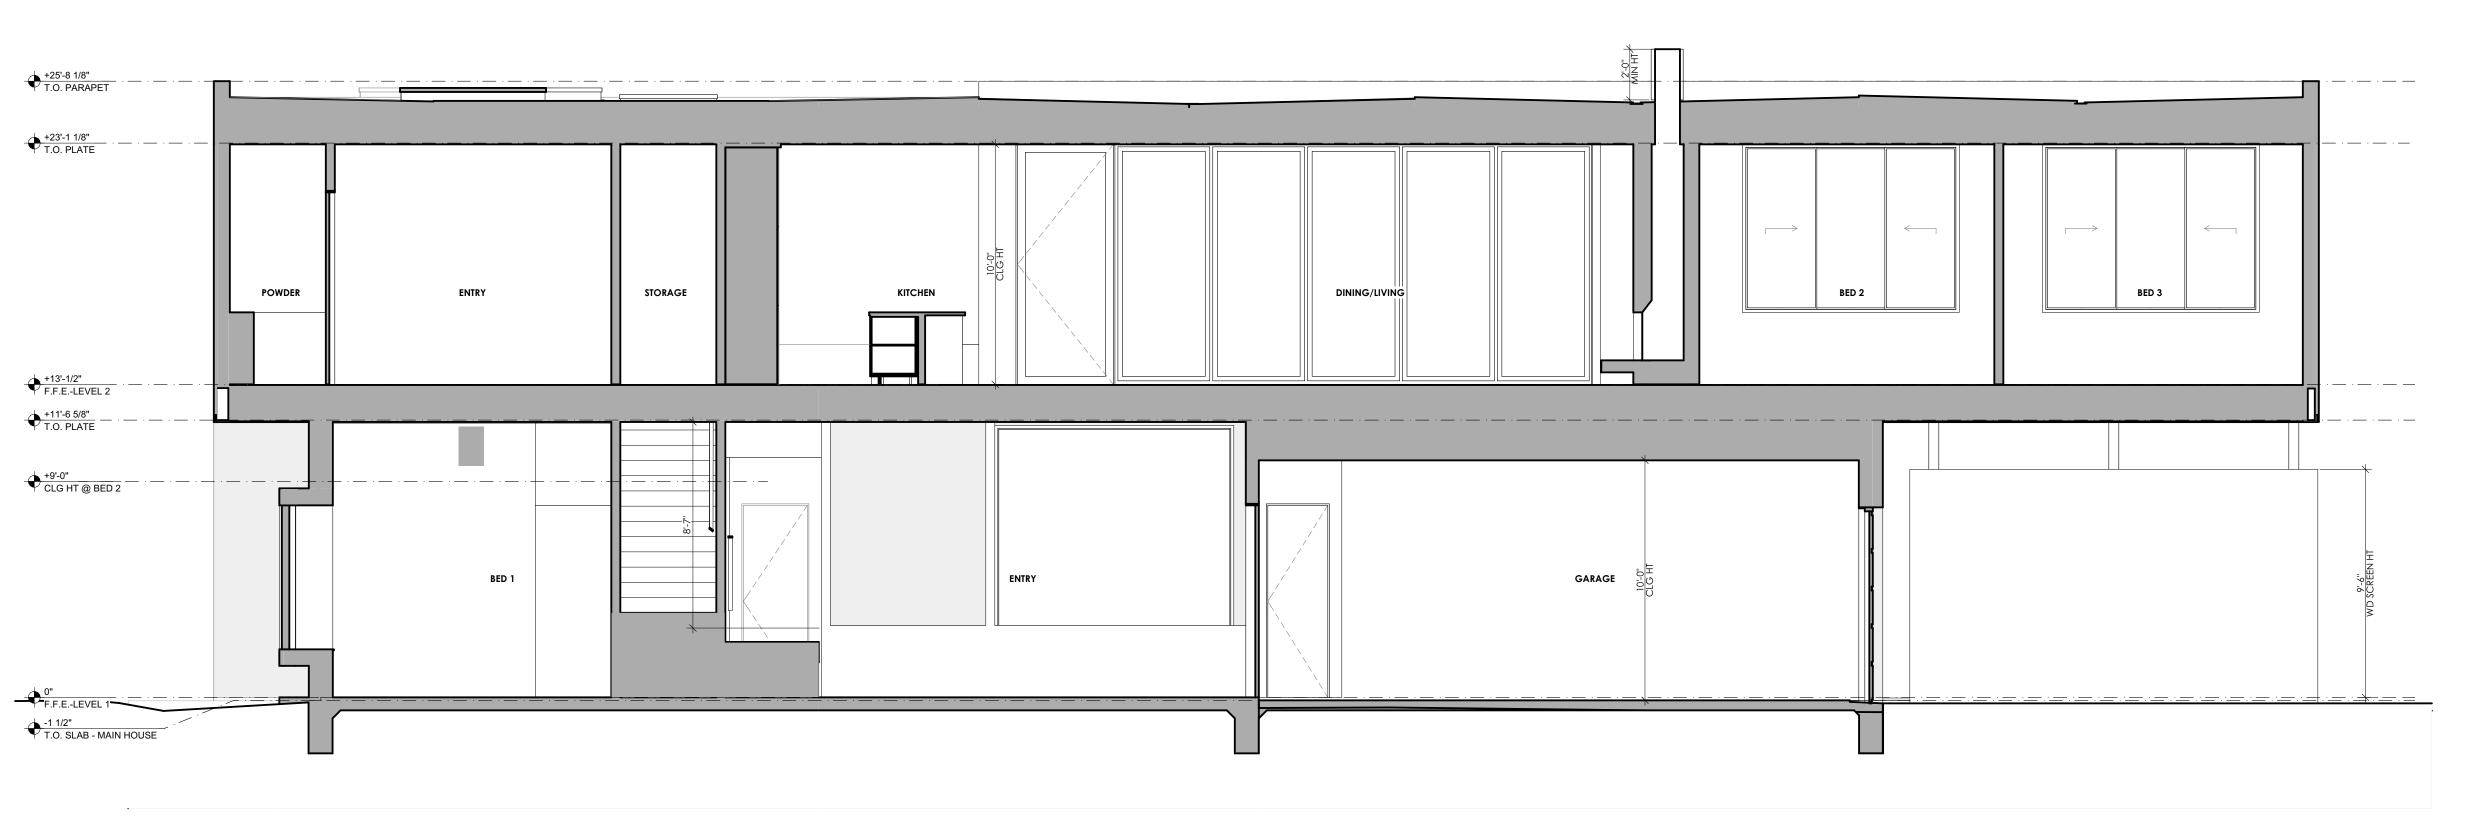BUILDING SECTION - TRANSVERSE

SCALE: 1/4" = 1'-0"



DO NOT SCALE DRAWING



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FOR CONSTRUCTION

DRAWING TITLE: **BUILDING SECTIONS**

SCALE: AS NOTED

SCALES ARE 50% OF NOTED WHEN PRINTED ON 11 X 17 PAPER

DATE: 6/19/2025

SHEET NUMBER:



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MOT FOR CONSTRUCTION

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FOR CONSTRUCTION

DRAWING TITLE:
BUILDING SECTIONS

SCALE: AS NOTED

SCALES ARE 50% OF NOTED WHEN PRINTED ON 11 X 17 PAPER

DATE: 6/19/2025

SHEET NUMBER:

A4.01

